



September 27, 2007

State of Utah, Division of Oil, Gas and Mining
ATTN: Diana Mason
PO Box 145801
Salt Lake City, UT 84114-5801

RE: Directional Drilling
Ute Tribal 4-8-5-2
Surface Hole: T5S R2E, Section 8: SW/4NW/4
2146' FNL 700' FWL
Bottom Hole: T5S R2E, Section 8: NW/4NW/4
660' FNL 664' FWL
Uintah County, Utah

Dear Ms. Mason;

Pursuant to the filing of Newfield Production Company's ("NPC") Application for Permit to Drill dated September 11, 2007, a copy of which is attached, for the above referenced well, and in accordance with Oil and Gas Conservation Rule R649-3-11, NPC hereby submits this letter as notice of our intention to directionally drill this well.

The surface hole location and bottom hole location of this well are both on The Ute Indian Tribe lands. Newfield certifies that Newfield and The Ute Indian Tribe own 100% of the working interest in all of the lands within 460 feet of the entire directional well bore. A copy of The Ute Indian Tribe's consent to directional drilling is attached.

NPC is permitting this well as a directional well due to surface issues.

NPC hereby requests our application for permit to drill be granted pursuant to R649-3-11. If you have any questions or require further information, please do not hesitate to contact the undersigned at 303-382-4444 or by email at reveland@newfield.com. Your consideration of this matter is greatly appreciated.

Sincerely,
NEWFIELD PRODUCTION COMPANY

A handwritten signature in cursive script that reads "Roxann Eveland".

Roxann Eveland
Land Associate

Attachments

RECEIVED
OCT 01 2007

DIV. OF OIL, GAS & MINING

UNITED STATES
DEPARTMENT OF THE INTERIOR
BUREAU OF LAND MANAGEMENT

APPLICATION FOR PERMIT TO DRILL OR REENTER


FORM APPROVED
OMB No. 1004-0136
Expires January 31, 2004

1a. Type of Work: <input checked="" type="checkbox"/> DRILL <input type="checkbox"/> REENTER		5. Lease Serial No. 2OG0005609
1b. Type of Well: <input checked="" type="checkbox"/> Oil Well <input type="checkbox"/> Gas Well <input type="checkbox"/> Other <input checked="" type="checkbox"/> Single Zone <input type="checkbox"/> Multiple Zone		6. If Indian, Allottee or Tribe Name Ute
2. Name of Operator Newfield Production Company		7. If Unit or CA Agreement, Name and No. N/A
3a. Address Route #3 Box 3630, Myton UT 84052		8. Lease Name and Well No. Ute Tribal 4-8-5-2E
3b. Phone No. (include area code) (435) 646-3721		9. API Well No.
4. Location of Well (Report location clearly and in accordance with any State requirements. *) At surface SW/NW 2146' FNL 700' FWL At proposed prod. zone NW/NW 660' FNL 664' FWL		10. Field and Pool, or Exploratory Undesignated
14. Distance in miles and direction from nearest town or post office* Approximatley 26.5 miles southeast of Myton, Utah		11. Sec., T., R., M., or Blk. and Survey or Area SW/NW Sec. 8, T5S R2E
15. Distance from proposed* location to nearest property or lease line, ft. (Also to nearest drig. unit line, if any) Approx. 656' /lse, NA' /f/unit NA	16. No. of Acres in lease NA	12. County or Parish Uintah
17. Spacing Unit dedicated to this well 40 Acres	13. State UT	
18. Distance from proposed location* to nearest well, drilling, completed, applied for, on this lease, ft. NA	19. Proposed Depth	20. BLM/BIA Bond No. on file B002792
21. Elevations (Show whether DF, KDB, RT, GL, etc.) 4854' GL	22. Approximate date work will start* 4th Quarter 2007	23. Estimated duration Approximately seven (7) days from spud to rig release.

24. Attachments

The following, completed in accordance with the requirements of Onshore Oil and Gas Order No.1, shall be attached to this form:

- | | |
|---|--|
| 1. Well plat certified by a registered surveyor. | 4. Bond to cover the operations unless covered by an existing bond on file (see Item 20 above). |
| 2. A Drilling Plan. | 5. Operator certification. |
| 3. A Surface Use Plan (if the location is on National Forest System Lands, the SUPO shall be filed with the appropriate Forest Service Office). | 6. Such other site specific information and/or plans as may be required by the authorized officer. |

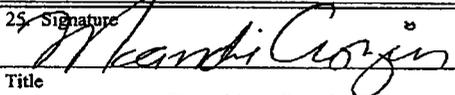25. Signature 	Name (Printed/Typed) Mandie Crozier	Date 9/11/07
Title Regulatory Specialist	Office	
Approved by (Signature)	Name (Printed/Typed)	Date
Title	Office	

Application approval does not warrant or certify the the applicant holds legal or equitable title to those rights in the subject lease which would entitle the applicant to conduct operations thereon.
Conditions of approval, if any, are attached.


Title 18 U.S.C. Section 1001 and Title 43 U.S.C. Section 1212, make it a crime for any person knowingly and willfully to make to any department or agency of the United States any false, fictitious or fraudulent statements or representations as to any matter within its jurisdiction.

*(Instructions on reverse)

T5S, R2E, U.S.B.&M.

NEWFIELD PRODUCTION COMPANY



WELL LOCATION, UTE TRIBAL 4-8-5-2,
 LOCATED AS SHOWN IN THE SW 1/4 NW
 1/4 OF SECTION 8, T5S, R2E, U.S.B.&M.
 UNITAH COUNTY, UTAH.

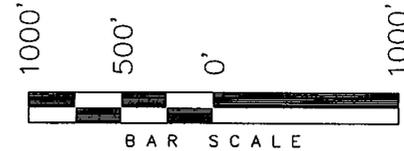

Note:

Lots were not labeled on the G.L.O.
 Plat, so we have not shown them.

THIS IS TO CERTIFY THAT THE ABOVE PLAT WAS
 PREPARED FROM FIELD NOTES OF ACTUAL SURVEYS
 MADE BY ME OR UNDER MY SUPERVISION AND THAT
 THE SAME ARE TRUE AND CORRECT TO THE BEST OF
 MY KNOWLEDGE AND BELIEF. No. 189377

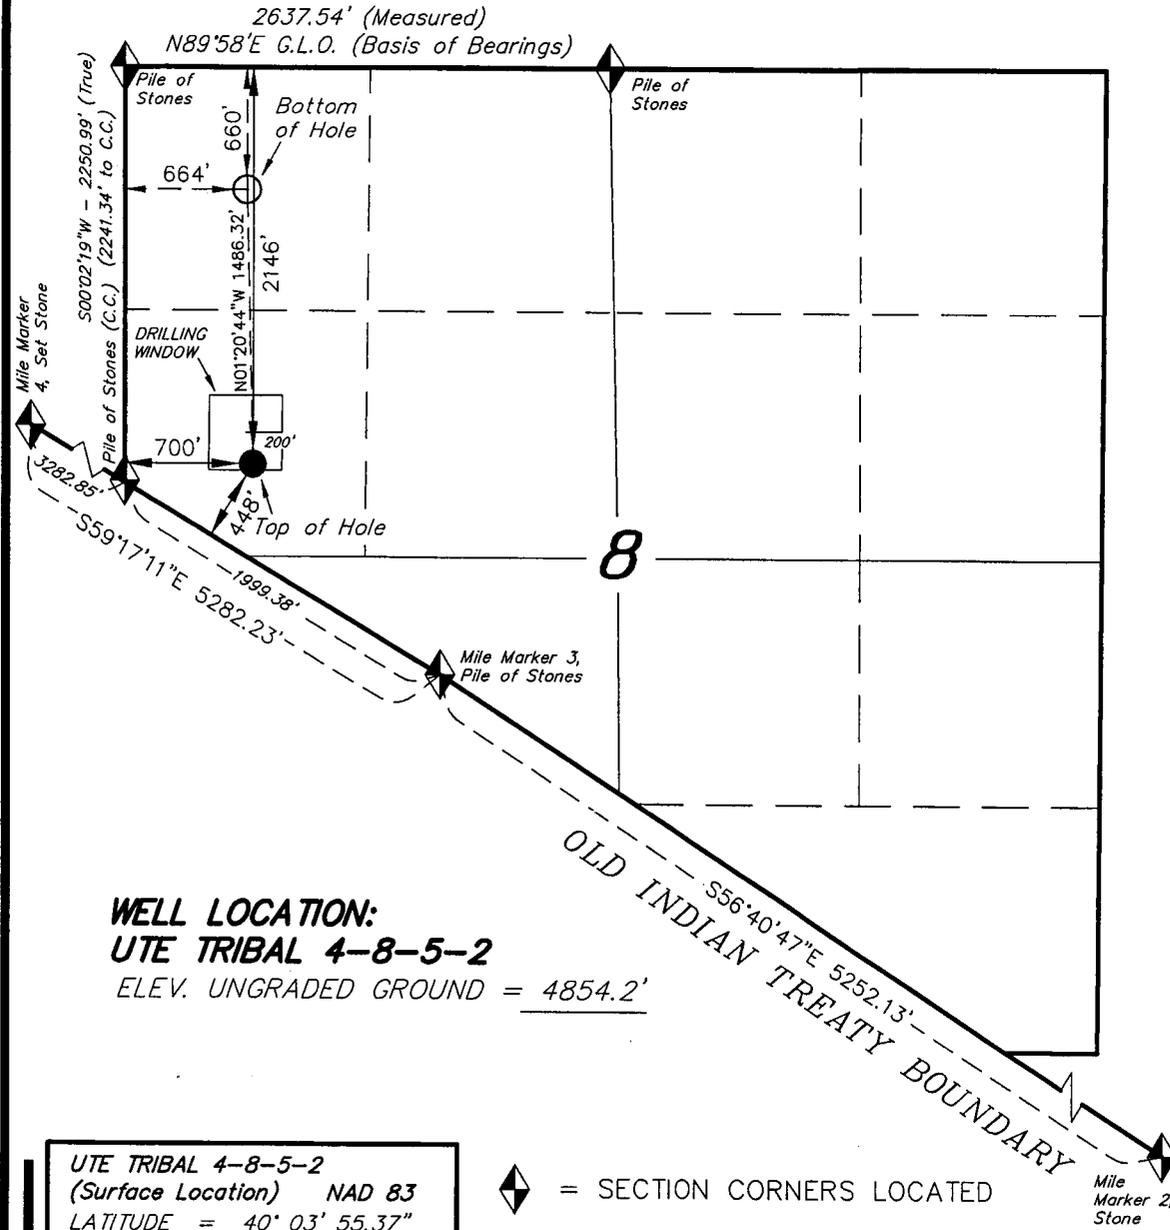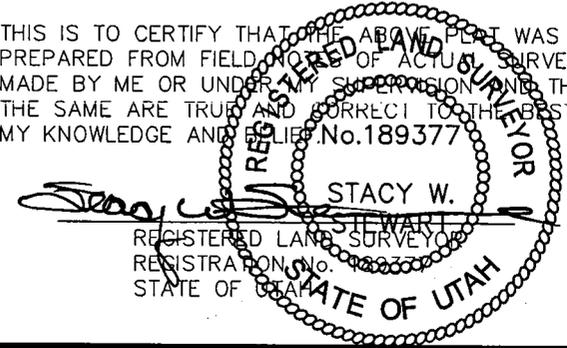

WELL LOCATION:
UTE TRIBAL 4-8-5-2
 ELEV. UNGRADED GROUND = 4854.2'

UTE TRIBAL 4-8-5-2
 (Surface Location) NAD 83
 LATITUDE = 40° 03' 55.37"
 LONGITUDE = 109° 47' 59.16"

◆ = SECTION CORNERS LOCATED

BASIS OF ELEV;
 U.S.G.S. 7-1/2 min QUAD (UTELAND BUTTE)

TRI STATE LAND SURVEYING & CONSULTING

180 NORTH VERNAL AVE. - VERNAL, UTAH 84078
 (435) 781-2501

DATE SURVEYED: 09-06-07	SURVEYED BY: C.M.
DATE DRAWN: 09-07-07	DRAWN BY: F.T.M.
REVISED:	SCALE: 1" = 1000'



September 14, 2007

Mike James
Ute Indian Tribe
Energy Minerals Dept.
P.O. Box 70
Fort Duchesne, UT 84026

Re: Directional Drilling
Ute Tribal 4-8-5-2
Uintah County, Utah

Dear Mr. James:

In accordance with Section 3.1.D of the Exploration & Development Agreement dated December 22, 2006 among the Ute Indian Tribe, Newfield Production Company and the Ute Distribution Corporation, please be advised that Newfield is requesting approval from the Utah Division of Oil, Gas & Mining for the following well:

Ute Tribal 4-8-5-2

Surface Hole Location: T5S R2E, Section 8: SW/4NW/4
2146' FNL 700' FWL

Bottom Hole Location: T5S R2E, Section 8: NW/4NW/4
660' FNL 664' FWL

Uintah County, Utah

This well will be drilled directionally due to surface issues. Pursuant to State of Utah R649-3-11, it is necessary to obtain your written concurrence with the directional drilling as an affected party.

Enclosed you will find a plat showing the surface hole location and bottom hole location of the above referenced well. If you are in agreement to this location, please verify your consent by signing and dating where indicated on page 2 of this letter and returning to my attention as soon as possible by fax to 303-893-0103.

If you have any questions or need further information, please do not hesitate to contact me at 303-382-4444 or by email at reveland@newfield.com. I appreciate your prompt attention to this matter.

Sincerely,


A handwritten signature in cursive script that reads "Roxann Eveland".

Roxann Eveland
Land Associate

cc: Roger Tullberg
Bob Ogle

UTE INDIAN TRIBE
ENERGY & MINERALS DEPT.

SEP 19 2007

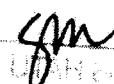RECEIVED BY 
FT. DUCHESNE, UTAH

Fax to: 303-893-0103
Newfield Production Company
Attn: Roxann Eveland

Re: Directional Drilling
Ute Tribal 4-8-5-2
Surface Hole Location: T5S R2E, Section 8: SW/4NW/4
2146' FNL 700' FWL
Bottom Hole Location: T5S R2E, Section 8: NW/4NW/4
660' FNL 664' FWL
Uintah County, Utah

Please be advised The Ute Indian Tribe does not have an objection to the proposed location of the
aforementioned well.

By: Curtis B. Cesspach
Curtis B. Cesspach - Chairman
Print Name and Title

Date: 9/24/07

NEWFIELD PRODUCTION COMPANY
UTE TRIBAL #4-8-5-2E
AT PROPOSED ZONE: NW/NW SECTION 8, T5S, R2E
AT SURFACE: SW/NW SECTION 8, T5S, R2E
UINTAH COUNTY, UTAH

ONSHORE ORDER NO. 1

DRILLING PROGRAM

1. **GEOLOGIC SURFACE FORMATION:**

Uinta formation of Upper Eocene Age

2. **ESTIMATED TOPS OF IMPORTANT GEOLOGIC MARKERS:**

Uinta	0' – 1,580'
Green River	1,580'
Wasatch	6,090'
TD	6,090'

3. **ESTIMATED DEPTHS OF ANTICIPATED WATER, OIL, GAS OR MINERALS:**

Green River Formation (Oil) 1,580' – 6,090'

Fresh water may be encountered in the Uinta Formation, but would not be expected below about 350'. All water shows and water bearing geologic units shall be reported to the geologic and engineering staff of the Vernal Office prior to running the next string of casing or before plugging orders are requested. All water shows must be reported within one (1) business day after being encountered.

All usable (<10,000 PPM TDS) water and prospectively valuable minerals (as described by BLM at onsite) encountered during drilling will be recorded by depth and adequately protected. This information shall be reported to the Vernal Office.

Detected water flows shall be sampled, analyzed, and reported to the geologic & engineering staff of the Vernal Office. The office may request additional water samples for further analysis. Usage of the State of Utah form *Report of Water Encountered* is acceptable, but not required.

The following information is requested for water shows and samples where applicable:

Location & Sampled Interval	Date Sampled
Flow Rate	Temperature
Hardness	pH
Water Classification (State of Utah)	Dissolved Calcium (Ca) (mg/l)
Dissolved Iron (Fe) (ug/l)	Dissolved Sodium (Na) (mg/l)
Dissolved Magnesium (Mg) (mg/l)	Dissolved Carbonate (CO ₃) (mg/l)
Dissolved Bicarbonate (NaHCO ₃) (mg/l)	Dissolved Chloride (Cl) (mg/l)
Dissolved Sulfate (SO ₄) (mg/l)	Dissolved Total Solids (TDS) (mg/l)

4. **PROPOSED CASING PROGRAM**

a. **Casing Design: Ute Tribal 4-8-5-2E**

Size	Interval		Weight	Grade	Coupling	Design Factors		
	Top	Bottom				Burst	Collapse	Tension
Surface casing 8-5/8" Hole Size 12 1/4"	0'	300'	24.0	J-55	STC	2,950 17.53	1,370 14.35	244,000 33.89
Prod casing 5-1/2" Hole Size 7 7/8"	0'	6,090'	15.5	J-55	LTC	4,810 2.48	4,040 2.09	217,000 2.30

Assumptions:

- 1) Surface casing max anticipated surface press (MASP) = Frac gradient – gas gradient
- 2) Prod casing MASP (production mode) = Pore pressure – gas gradient
- 3) All collapse calculations assume fully evacuated casing w/ gas gradient
- 4) All tension calculations assume air weight

Frac gradient at surface casing shoe = 13.0 ppg
 Pore pressure at surface casing shoe = 8.33 ppg
 Pore pressure at prod casing shoe = 8.33 ppg
 Gas gradient = 0.115 psi/ft

All casing shall be new or, if used, inspected and tested. Used casing shall meet or exceed API standards for new casing.

All casing strings shall have a minimum of 1 (one) centralizer on each of the bottom three (3) joints.

b. **Cementing Design: Ute Tribal 4-8-5-2E**

Job	Fill	Description	Sacks	OH Excess*	Weight (ppg)	Yield (ft ³ /sk)
			ft ³			
Surface casing	300'	Class G w/ 2% CaCl	138 161	30%	15.8	1.17
Prod casing Lead	4,090'	Prem Lite II w/ 10% gel + 3% KCl	283 921	30%	11.0	3.26
Prod casing Tail	2,000'	50/50 Poz w/ 2% gel + 3% KCl	363 451	30%	14.3	1.24

- *Actual volume pumped will be 15% over the caliper log
- Compressive strength of lead cement: 1800 psi @ 24 hours, 2250 psi @ 72 hours
 - Compressive strength of tail cement: 2500 psi @ 24 hours

Waiting On Cement: A minimum of four (4) hours shall elapse prior to attempting any pressure testing of the BOP equipment which would subject the surface casing cement to pressure, and a minimum of six (6) hours shall elapse before drilling out of the wiper plug, cement, or shoe is begun. WOC time shall be recorded in the Driller's Log. Compressive Strength shall be a minimum of 500 psi prior to drilling out.

The Vernal BLM Office shall be notified, with sufficient lead time, in order to have a BLM representative on location while running all casing strings and cementing.

The 8-5/8" surface casing shall in all cases be cemented back to surface. In the event that during the primary surface cementing operation the cement does not circulate to surface, or if the cement level should fall back more than 8 feet from surface, then a remedial surface cementing operation shall be performed to insure adequate isolation and stabilization of the surface casing.

The production casing cementing program shall be conducted as approved to protect and/or isolate all usable water zones, potentially productive zones, lost circulation zones, abnormally pressured zones, and any prospectively valuable deposits of minerals.

As a minimum, usable water zones shall be isolated and/or protected by having a cement top for the production casing at least 200 feet above the base of the usable water. If gilsonite is encountered while drilling, it shall be isolated and/or protected via the cementing program.

Top plugs shall be used to reduce contamination of cement by displacement fluid. A bottom plug or other acceptable technique, such as a suitable preflush fluid, inner string cement method, etc., shall be utilized to help isolate the cement from contamination by the mud being displaced ahead of the cement slurry.

All casing strings below the conductor shall be pressure tested to 0.22 psi per foot of casing string length or to 1500 psi, whichever is greater, but not to exceed 70% of the minimum internal yield. If pressure declines more than 10% in 30 minutes, corrective action shall be taken.

A Form 3160-5, "Sundry Notices and Reports on Wells" shall be filed with the Vernal Office Manager within 30 days after the work is completed. This report must include the following information:

Setting of each string of casing showing the size, grade, weight of casing set, depth, amounts and type of cement used, whether cement circulated or the top of the cement behind the casing, depth of the cementing tools used, casing test method and results, and the date of the work done. Spud date will be shown on the first reports submitted.

5. **MINIMUM SPECIFICATIONS FOR PRESSURE CONTROL:**

The Company's Class 2M minimum specifications for pressure control equipment for a standard Monument Butte development well are as follows:

A 2000 psi WP hydraulic BOP stack consisting of two ram preventers (double or two singles) and either an annular preventer or a rotating head. If no annular preventer is used, ram blocks will be changed to match the outside diameter of casing and the stack will be retested prior to running any casing string.

Connections - All components on the stack and choke and kill lines shall have either flanged, studded, clamp hub or equivalent proprietary connections except control line outlets and pressure gauges.

Choke Manifold - The minimum equipment requirements are shown in **Exhibit C**. The choke manifold shall be located at least 5 feet from the BOP stack, outside the substructure.

Pressure Monitoring - A means of monitoring the inlet pressure of the choke manifold shall be provided. The capability to isolate this outlet shall be provided.

Drillstring Control Devices - An upper and lower kelly valve, drillstring safety valve including correct closing handle, and an inside BOP shall be provided. The safety valve and inside BOP shall have connections or crossovers to fit all tubulars with OD to allow adequate clearance for running in the hole. All drillstring valves shall be rated to the required BOP WP.

The BOP and related equipment shall meet the minimum requirements of Onshore Oil and Gas Order No. 2 for equipment and testing requirements, procedures, etc., for a 2M system, and individual components shall be operable as designed.

Function test of the BOP equipment shall be made daily. All required BOP tests and/or drills shall be recorded in the Driller's report.

Chart recorders will be used for all pressure tests. Test charts, with individual test results identified, shall be maintained on location while drilling and shall be made available to BLM representatives upon request.

6. **TYPE AND CHARACTERISTICS OF THE PROPOSED CIRCULATION MUDS:**

From surface to ±3200 feet will be drilled with either fresh water or an air/mist system, depending on the drilling contractor's preference. From about 3200 feet. or in the case of the air/mist system when hole conditions dictate, to TD, a fresh water system will be utilized. Clay inhibition and hole stability will be achieved with a KCl substitute additive. This additive will be identified in the APD and reviewed to determine if the reserve pit shall be lined. This fresh water system will typically contain Total Dissolved Solids (TDS) of less than 3000 PPM. Anticipated mud weight is 8.4 lbs/gal. If necessary to control formation fluids or pressure, the system will be weighted with the addition of bentonite gel, and if pressure conditions warrant, with barite.

No chromate additives will be used in the mud system on Federal and/or Indian lands without prior BLM approval to ensure adequate protection of fresh aquifers.

No chemicals subject to reporting under SARA Title III in an amount equal to or greater than 10,000 pounds will be used, produced, stored, transported, or disposed of annually in association with the drilling, testing, or completing of this well. Furthermore, no extremely hazardous substances, as defined in 40 CFR 355, in threshold planning quantities, will be used, produced, stored, transported, or disposed of in association with the drilling, testing, or completing of this well.

Hazardous substances specifically listed by the EPA as a hazardous waste or demonstrating a characteristic of a hazardous waste will not be used in drilling, testing, or completion operations.

Newfield Production will **visually** monitor pit levels and flow from the well during drilling operations.

7. **AUXILIARY SAFETY EQUIPMENT TO BE USED:**

Auxiliary safety equipment will be a Kelly Cock, bit float, and a TIW valve with drill pipe threads.

8. **TESTING, LOGGING AND CORING PROGRAMS:**

a. **Logging Program:**

(the log types run may change at the discretion of the geologist)

FDC/CNL/GR/DLL: TD - 3,200'

CBL: A cement bond log will be run from TD to the cement top of the production casing.
A field copy will be submitted to the Vernal BLM Office.

- b. **Cores:** As deemed necessary.
- c. **Drill Stem Tests:** No DSTs are planned in the Green River.

Drill stem tests, if they are run, will adhere to the following requirements: Initial opening of the drill stem test tools shall be restricted to daylight hours unless specific approval to start during other hours is obtained from the Authorized Officer (AO). However, DSTs may be allowed to continue at night if the test was initiated during daylight hours and the rate of flow is stabilized and if adequate lighting is available (i.e., lighting which is adequate for visibility and vapor-proof for safe operations). Packers can be released but tripping shall not begin before daylight, unless prior approval is obtained from the AO. Closed chamber DSTs may be performed day or night.

Some means of reverse circulation shall be provided in case of flow to the surface showing evidence of hydrocarbons.

Separation equipment required for the anticipated recovery shall be properly installed before a test starts.

If a DST is performed, all engines within 100 feet of the wellbore that are required to be operational during the test shall have spark arresters or water-cooled exhausts.

Please refer to the Monument Butte Field Standard Operation Procedure (SOP).

9. **ANTICIPATED ABNORMAL PRESSURE OR TEMPERATURE:**

No abnormal temperatures or pressures are anticipated. No hydrogen sulfide has been encountered or is known to exist from previous drilling in the area at this depth. Maximum anticipated bottomhole pressure will approximately equal total depth in feet multiplied by a 0.433 psi/foot gradient.

10. **ANTICIPATED STARTING DATE AND DURATION OF THE OPERATIONS:**

a. **Drilling Activity**

Anticipated Commencement Date:	Upon approval of the site specific APD.
Drilling Days:	Approximately 7 days.
Completion Days:	Approximately 10 - 14 days.

b. **Notification of Operations**

The Vernal BLM office will be notified at least 24 hours **prior** to the commencement of spudding the well (to be followed with a Sundry Notice, Form 3160-5), of initiating pressure tests of the blowout preventer and related equipment, and running casing and cementing of all casing strings. Notification will be made during regular work hours (7:45 a.m.-4:30 p.m., Monday - Friday except holidays).

Immediate Report: Spills, blowouts, fires, leaks, accidents, or any other unusual occurrences shall be promptly reported in accordance with the appropriate regulations, Onshore Orders, or BLM policy.

No location will be constructed or moved, no well will be plugged, and no drilling or workover equipment will be removed from a well to be placed in suspended status without

prior approval from the AO. If operations are to be suspended, prior approval of the AO will be obtained and notification given to the BLM before resumption of operations.

Daily drilling and completion reports shall be submitted to the Vernal BLM Office on a weekly basis.

Whether the well is completed as a dry hole or a producer, the "Well Completion and Recompletion Report and Log" (Form 3160-4) will be submitted not later than 30 days after completion of the well or after completion of operations being performed, in accordance with 43 CFR 3164. One copy of all logs, core descriptions, core analyses, well test data, geologic summaries, sample description, and all other surveys or data obtained and compiled during the drilling, workover, and/or completion operations will be filed with Form 3160-4. Samples (cuttings, fluids, and/or gases) will be submitted when requested by the Authorized Officer (AO).

A completion rig will be used for completion operations after the wells are stimulated to run the production tubing.. All conditions of this approved plan will be applicable during all operations conducted with the completion rig.

Operator shall report production data to the MMS pursuant to 30 CFR 216.5 using form MMS/3160. In accordance with Onshore Oil and Gas Order No. 1, a well will be reported on form 3160-6, "Monthly Report of Operations," starting with the month in which operations commence and continue each month until the well is physically plugged and abandoned. This report will be filed with the Vernal BLM Office.

The date on which production is commenced or resumed will be construed for oil wells as the date on which liquid hydrocarbons are first sold or shipped from a temporary storage facility, such as a test tank, and for which a run ticket is required to be generated, or the date on which liquid hydrocarbons are first produced into a permanent storage facility, whichever occurs first; and for gas wells, as the date on which associated liquid hydrocarbons are first sold or shipped from a temporary storage facility, such as a test tank, and for which a run ticket is required to be generated, or the date on which gas is measured through permanent metering facilities, whichever occurs first.

Should the well be successfully completed for production, the AO will be notified when the well is placed in a producing status. Such notification will be sent by written communication not later than 5 days following the date when the well is placed on production.

Pursuant to Onshore Order No. 7, with the approval of the AO, produced water may be temporarily disposed of into unlined pits for a period of up to 90 days. During this period, an application for approval of the permanent disposal method must be submitted to the AO.

Pursuant to NTL-4A, lessees or operators are authorized to vent/flare gas during the initial well evaluation tests, not to exceed 30 days or the production of 50 MMCF of gas, whichever occurs first. An application must be filed with the AO and approval received for any venting/flaring of gas beyond the initial 30 days or authorized test period.

A schematic facilities diagram, as required by 43 CFR 3162.7-5(b.9.d), shall be submitted to the Vernal BLM Office within 60 days of installation or first production, whichever occurs first. All site security regulations, as specified in Onshore Oil & Gas Order No. 3, shall be adhered to. All product lines entering and leaving hydrocarbon storage tanks will be effectively sealed in accordance with 43 CFR 3162.7-5(b.4).

Well abandonment operations shall not be commenced without the prior approval of the AO. In the case of newly drilled dry holes or failures, and in emergency situations, oral approval



will be obtained from the AO. A "Subsequent Report of Abandonment", Form 3160-5, will be filed with the Authorized Officer within 30 days following completion of the well for abandonment. This report will indicate placement of the plugs and current status of the surface restoration. Final Abandonment will not be approved until the surface reclamation work required by the approved APD or approved abandonment notice has been completed to the satisfaction of the AO, or the appropriate surface managing agency.

Pursuant to Onshore Oil and Gas Order No. 1, lessees and operators have the responsibility to see that their exploration, development, production, and construction operations are conducted in a manner which conforms with applicable Federal laws and regulations and with the State and local laws, to the extent to which they are applicable, to operations on Federal or Indian lands.

WELL DETAILS: Ute Tribal 4-8-5-2

GL 4853' & RKB 12' @ 4865.00R (NDSI 2) 4853.00
 Northing Easting Latitude Longitude Slot
 7197075.66 2116235.81 40° 3' 55.370 N 109° 47' 59.160 W

T M
 Azimuths to True North
 Magnetic North: 11.68°
 Magnetic Field
 Strength: 52715.6nT
 Dip Angle: 65.96°
 Date: 2007-09-21
 Model: IGRF2005-10

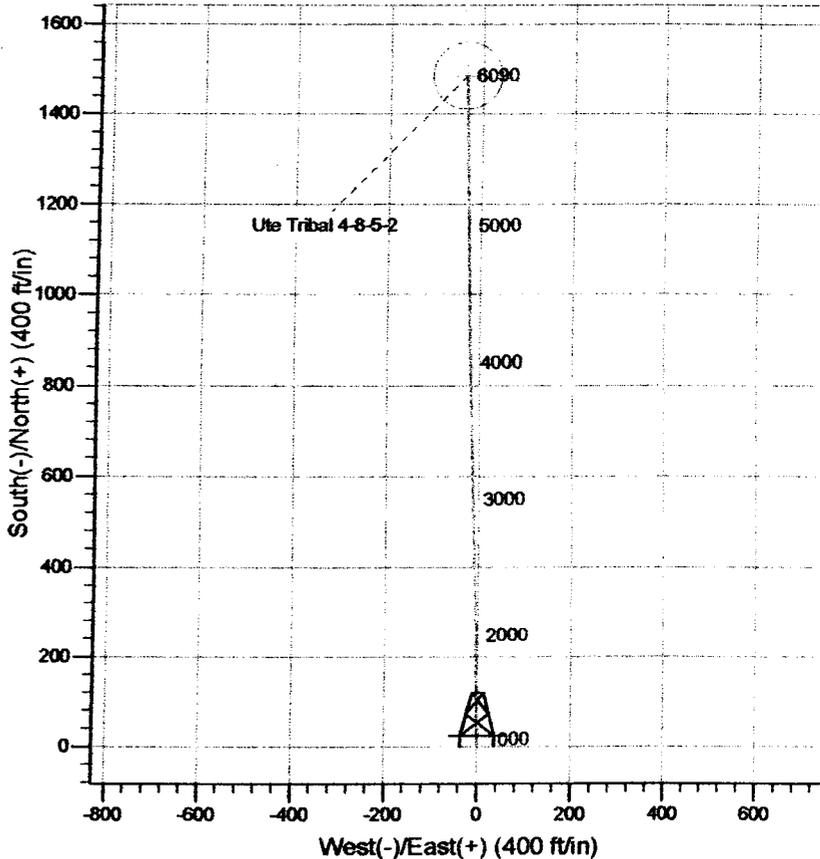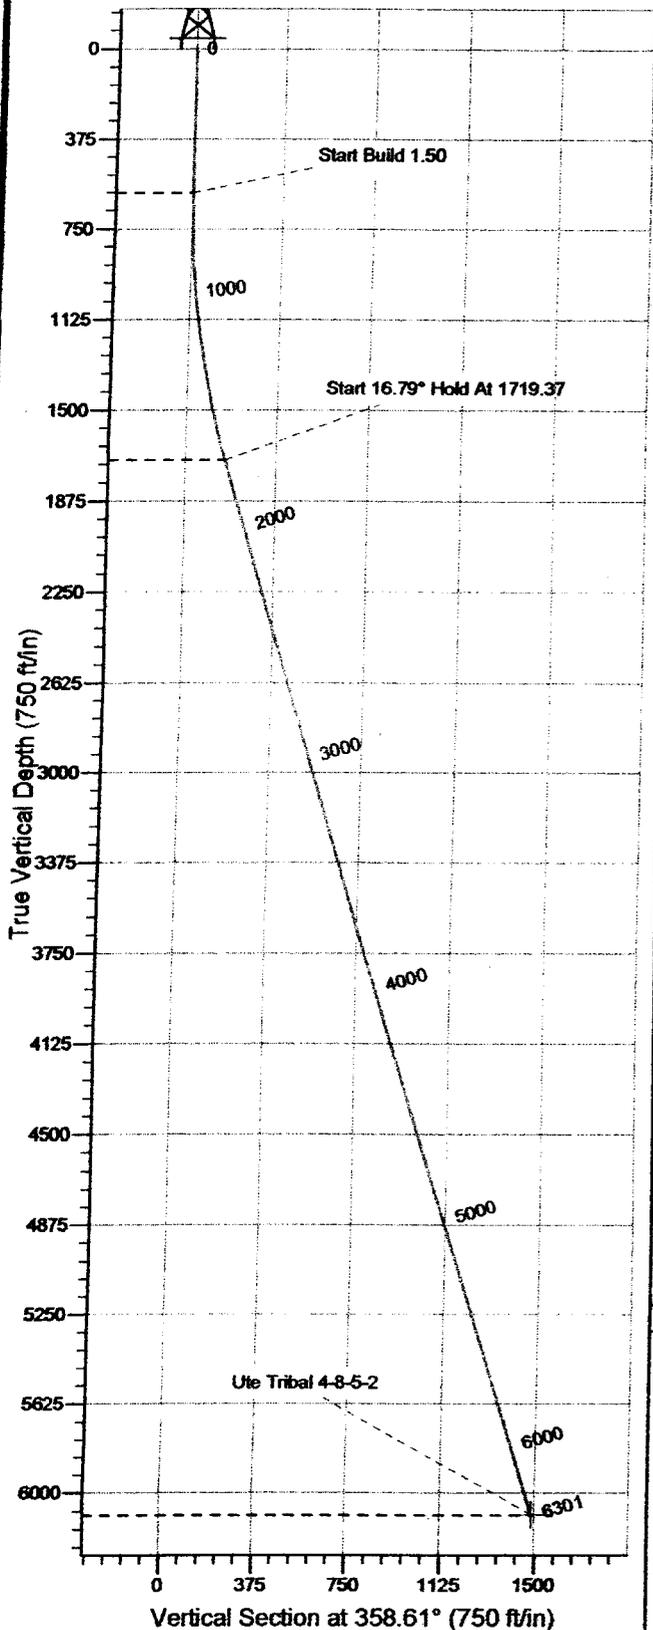FORMATION TOP DETAILS

Plan: Plan #1 (Ute Tribal 4-8-5-2/OH)

Created By: Rex Hall Date: 2007-09-21

PROJECT DETAILS: Uintah County, UT NAD83 UTC

Geodetic System: US State Plane 1983
 Datum: North American Datum 1983
 Ellipsoid: GRS 1980
 Zone: Utah Central Zone

System Datum: Mean Sea Level
 Local North: True

SECTION DETAILS

Sec	MD	Inc	Azi	TVD	+N-S	+E-W	DLeg	TFace	VSec	Target
1	0.00	0.00	0.00	0.00	0.00	0.00	0.00	0.00	0.00	
2	600.00	0.00	0.00	600.00	0.00	0.00	0.00	0.00	0.00	
3	1719.37	16.79	358.61	1703.41	162.80	-3.94	1.50	358.61	162.80	
4	6301.29	16.79	358.61	6090.00	1486.00	-36.00	0.00	0.001486.00		Ute Tribal 4-8-5-2

Newfield Exploration Co.

Uintah County, UT NAD83 UTC

Ute Tribal 4-8-5-2

Ute Tribal 4-8-5-2

OH

Plan: Plan #1

Standard Planning Report

21 September, 2007

Scientific Drilling

Planning Report

Database: MultiUserEDM
Company: Newfield Exploration Co.
Project: Uintah County, UT NAD83 UTC
Site: Ute Tribal 4-8-5-2
Well: Ute Tribal 4-8-5-2
Wellbore: OH
Design: Plan #1

Local Co-ordinate Reference: Well Ute Tribal 4-8-5-2
TVD Reference: GL 4853' & RKB 12' @ 4865.00ft (NDSI 2)
MD Reference: GL 4853' & RKB 12' @ 4865.00ft (NDSI 2)
North Reference: True
Survey Calculation Method: Minimum Curvature

Project	Uintah County, UT NAD83 UTC		
Map System:	US State Plane 1983	System Datum:	Mean Sea Level
Geo Datum:	North American Datum 1983		
Map Zone:	Utah Central Zone		

Site	Ute Tribal 4-8-5-2, Sec 8, T5S R2E				
Site Position:		Northing:	7,197,075.66 ft	Latitude:	40° 3' 55.370 N
From:	Lat/Long	Easting:	2,116,235.81 ft	Longitude:	109° 47' 59.160 W
Position Uncertainty:	0.00 ft	Slot Radius:	in	Grid Convergence:	1.09 °

Well	Ute Tribal 4-8-5-2, 2146' FNL & 700' FWL					
Well Position	+N-S	0.00 ft	Northing:	7,197,075.66 ft	Latitude:	40° 3' 55.370 N
	+E-W	0.00 ft	Easting:	2,116,235.81 ft	Longitude:	109° 47' 59.160 W
Position Uncertainty		0.00 ft	Wellhead Elevation:	ft	Ground Level:	4,853.00 ft

Wellbore	OH				
Magnetics	Model Name	Sample Date	Declination	Dip Angle	Field Strength
	IGRF2005-10	2007-09-21	(°)	(°)	(nT)
			11.68	65.96	52,716

Design	Plan #1			
Audit Notes:				
Version:	Phase:	PLAN	Tie On Depth:	0.00
Vertical Section:	Depth From (TVD)	+N-S	+E-W	Direction
	(ft)	(ft)	(ft)	(°)
	0.00	0.00	0.00	358.61

Plan Sections										
Measured Depth	Inclination	Azimuth	Vertical Depth	+N-S	+E-W	Dogleg Rate	Build Rate	Turn Rate	TFO	Target
(ft)	(°)	(°)	(ft)	(ft)	(ft)	(°/100ft)	(°/100ft)	(°/100ft)	(°)	
0.00	0.00	0.00	0.00	0.00	0.00	0.00	0.00	0.00	0.00	
600.00	0.00	0.00	600.00	0.00	0.00	0.00	0.00	0.00	0.00	
1,719.37	16.79	358.61	1,703.41	162.80	-3.94	1.50	1.50	0.00	358.61	
6,301.29	16.79	358.61	6,090.00	1,486.00	-36.00	0.00	0.00	0.00	0.00	Ute Tribal 4-8-5-2

Scientific Drilling

Planning Report

Database: MultiUserEDM
Company: Newfield Exploration Co.
Project: Uintah County, UT NAD83 UTC
Site: Ute Tribal 4-8-5-2
Well: Ute Tribal 4-8-5-2
Wellbore: OH
Design: Plan #1

Local Co-ordinate Reference: Well Ute Tribal 4-8-5-2
TVD Reference: GL 4853' & RKB 12' @ 4865.00ft (NDSI 2)
MD Reference: GL 4853' & RKB 12' @ 4865.00ft (NDSI 2)
North Reference: True
Survey Calculation Method: Minimum Curvature

Planned Survey

Measured Depth (ft)	Inclination (°)	Azimuth (°)	Vertical Depth (ft)	+N/-S (ft)	+E/-W (ft)	Vertical Section (ft)	Dogleg Rate (°/100ft)	Build Rate (°/100ft)	Turn Rate (°/100ft)
0.00	0.00	0.00	0.00	0.00	0.00	0.00	0.00	0.00	0.00
100.00	0.00	0.00	100.00	0.00	0.00	0.00	0.00	0.00	0.00
200.00	0.00	0.00	200.00	0.00	0.00	0.00	0.00	0.00	0.00
300.00	0.00	0.00	300.00	0.00	0.00	0.00	0.00	0.00	0.00
400.00	0.00	0.00	400.00	0.00	0.00	0.00	0.00	0.00	0.00
500.00	0.00	0.00	500.00	0.00	0.00	0.00	0.00	0.00	0.00
600.00	0.00	0.00	600.00	0.00	0.00	0.00	0.00	0.00	0.00
Start Build 1.50									
700.00	1.50	358.61	699.99	1.31	-0.03	1.31	1.50	1.50	0.00
800.00	3.00	358.61	799.91	5.23	-0.13	5.23	1.50	1.50	0.00
900.00	4.50	358.61	899.69	11.77	-0.29	11.77	1.50	1.50	0.00
1,000.00	6.00	358.61	999.27	20.92	-0.51	20.92	1.50	1.50	0.00
1,100.00	7.50	358.61	1,098.57	32.67	-0.79	32.68	1.50	1.50	0.00
1,200.00	9.00	358.61	1,197.54	47.01	-1.14	47.03	1.50	1.50	0.00
1,300.00	10.50	358.61	1,296.09	63.94	-1.55	63.96	1.50	1.50	0.00
1,400.00	12.00	358.61	1,394.16	83.45	-2.02	83.47	1.50	1.50	0.00
1,500.00	13.50	358.61	1,491.70	105.51	-2.56	105.54	1.50	1.50	0.00
1,600.00	15.00	358.61	1,588.62	130.12	-3.15	130.15	1.50	1.50	0.00
1,700.00	16.50	358.61	1,684.86	157.25	-3.81	157.30	1.50	1.50	0.00
1,719.37	16.79	358.61	1,703.41	162.80	-3.94	162.84	1.50	1.50	0.00
Start 16.79° Hold At 1719.37									
1,800.00	16.79	358.61	1,780.61	186.08	-4.51	186.14	0.00	0.00	0.00
1,900.00	16.79	358.61	1,876.35	214.96	-5.21	215.02	0.00	0.00	0.00
2,000.00	16.79	358.61	1,972.08	243.84	-5.91	243.91	0.00	0.00	0.00
2,100.00	16.79	358.61	2,067.82	272.72	-6.61	272.80	0.00	0.00	0.00
2,200.00	16.79	358.61	2,163.56	301.60	-7.31	301.69	0.00	0.00	0.00
2,300.00	16.79	358.61	2,259.29	330.48	-8.01	330.57	0.00	0.00	0.00
2,400.00	16.79	358.61	2,355.03	359.36	-8.71	359.46	0.00	0.00	0.00
2,500.00	16.79	358.61	2,450.77	388.23	-9.41	388.35	0.00	0.00	0.00
2,600.00	16.79	358.61	2,546.50	417.11	-10.11	417.24	0.00	0.00	0.00
2,700.00	16.79	358.61	2,642.24	445.99	-10.80	446.12	0.00	0.00	0.00
2,800.00	16.79	358.61	2,737.98	474.87	-11.50	475.01	0.00	0.00	0.00
2,900.00	16.79	358.61	2,833.71	503.75	-12.20	503.90	0.00	0.00	0.00
3,000.00	16.79	358.61	2,929.45	532.63	-12.90	532.79	0.00	0.00	0.00
3,100.00	16.79	358.61	3,025.19	561.51	-13.60	561.67	0.00	0.00	0.00
3,200.00	16.79	358.61	3,120.92	590.39	-14.30	590.56	0.00	0.00	0.00
3,300.00	16.79	358.61	3,216.66	619.27	-15.00	619.45	0.00	0.00	0.00
3,400.00	16.79	358.61	3,312.40	648.14	-15.70	648.33	0.00	0.00	0.00
3,500.00	16.79	358.61	3,408.13	677.02	-16.40	677.22	0.00	0.00	0.00
3,600.00	16.79	358.61	3,503.87	705.90	-17.10	706.11	0.00	0.00	0.00
3,700.00	16.79	358.61	3,599.61	734.78	-17.80	735.00	0.00	0.00	0.00
3,800.00	16.79	358.61	3,695.34	763.66	-18.50	763.88	0.00	0.00	0.00
3,900.00	16.79	358.61	3,791.08	792.54	-19.20	792.77	0.00	0.00	0.00
4,000.00	16.79	358.61	3,886.82	821.42	-19.90	821.66	0.00	0.00	0.00
4,100.00	16.79	358.61	3,982.55	850.30	-20.60	850.55	0.00	0.00	0.00
4,200.00	16.79	358.61	4,078.29	879.18	-21.30	879.43	0.00	0.00	0.00
4,300.00	16.79	358.61	4,174.03	908.06	-22.00	908.32	0.00	0.00	0.00
4,400.00	16.79	358.61	4,269.76	936.93	-22.70	937.21	0.00	0.00	0.00
4,500.00	16.79	358.61	4,365.50	965.81	-23.40	966.10	0.00	0.00	0.00
4,600.00	16.79	358.61	4,461.24	994.69	-24.10	994.98	0.00	0.00	0.00
4,700.00	16.79	358.61	4,556.97	1,023.57	-24.80	1,023.87	0.00	0.00	0.00
4,800.00	16.79	358.61	4,652.71	1,052.45	-25.50	1,052.76	0.00	0.00	0.00
4,900.00	16.79	358.61	4,748.45	1,081.33	-26.20	1,081.64	0.00	0.00	0.00

Scientific Drilling

Planning Report

Database: MultiUserEDM
Company: Newfield Exploration Co.
Project: Uintah County, UT NAD83 UTC
Site: Ute Tribal 4-8-5-2
Well: Ute Tribal 4-8-5-2
Wellbore: OH
Design: Plan #1

Local Co-ordinate Reference:
TVD Reference:
MD Reference:
North Reference:
Survey Calculation Method:

Well Ute Tribal 4-8-5-2
 GL 4853' & RKB 12' @ 4865.00ft (NDSI 2)
 GL 4853' & RKB 12' @ 4865.00ft (NDSI 2)
 True
 Minimum Curvature

Planned Survey

Measured Depth (ft)	Inclination (°)	Azimuth (°)	Vertical Depth (ft)	+N-S (ft)	+E-W (ft)	Vertical Section (ft)	Dogleg Rate (°/100ft)	Build Rate (°/100ft)	Turn Rate (°/100ft)
5,000.00	16.79	358.61	4,844.19	1,110.21	-26.90	1,110.53	0.00	0.00	0.00
5,100.00	16.79	358.61	4,939.92	1,139.08	-27.60	1,139.42	0.00	0.00	0.00
5,200.00	16.79	358.61	5,035.66	1,167.96	-28.30	1,168.31	0.00	0.00	0.00
5,300.00	16.79	358.61	5,131.40	1,196.84	-28.99	1,197.19	0.00	0.00	0.00
5,400.00	16.79	358.61	5,227.13	1,225.72	-29.69	1,226.08	0.00	0.00	0.00
5,500.00	16.79	358.61	5,322.87	1,254.60	-30.39	1,254.97	0.00	0.00	0.00
5,600.00	16.79	358.61	5,418.61	1,283.48	-31.09	1,283.86	0.00	0.00	0.00
5,700.00	16.79	358.61	5,514.34	1,312.36	-31.79	1,312.74	0.00	0.00	0.00
5,800.00	16.79	358.61	5,610.08	1,341.24	-32.49	1,341.63	0.00	0.00	0.00
5,900.00	16.79	358.61	5,705.82	1,370.12	-33.19	1,370.52	0.00	0.00	0.00
6,000.00	16.79	358.61	5,801.55	1,398.99	-33.89	1,399.40	0.00	0.00	0.00
6,100.00	16.79	358.61	5,897.29	1,427.87	-34.59	1,428.29	0.00	0.00	0.00
6,200.00	16.79	358.61	5,993.03	1,456.75	-35.29	1,457.18	0.00	0.00	0.00
6,300.00	16.79	358.61	6,088.76	1,485.63	-35.99	1,486.07	0.00	0.00	0.00
6,301.29	16.79	358.61	6,090.00	1,486.00	-36.00	1,486.44	0.00	0.00	0.00

TD at 6301.29 - Ute Tribal 4-8-5-2

Targets

Target Name

- hit/miss target	Dip Angle (°)	Dip Dir. (°)	TVD (ft)	+N-S (ft)	+E-W (ft)	Northing (ft)	Easting (ft)	Latitude	Longitude
- Shape									
Ute Tribal 4-8-5-2	0.00	0.00	6,090.00	1,486.00	-36.00	7,198,560.71	2,116,171.57	40° 4' 10.056 N	109° 47' 59.623 W
- plan hits target									
- Circle (radius 75.00)									

Plan Annotations

Measured Depth (ft)	Vertical Depth (ft)	Local Coordinates		Comment
		+N-S (ft)	+E-W (ft)	
600.00	600.00	0.00	0.00	Start Build 1.50
1,719.37	1,703.41	162.80	-3.94	Start 16.79° Hold At 1719.37
6,301.29	6,090.00	1,486.00	-36.00	TD at 6301.29

NEWFIELD PRODUCTION COMPANY
UTE TRIBAL #4-8-5-2E
AT PROPOSED ZONE: NW/NW SECTION 8, T5S, R2E
AT SURFACE: SW/NW SECTION 8, T5S, R2E
UINTAH COUNTY, UTAH

THIRTEEN POINT SURFACE PROGRAM

1. EXISTING ROADS

See attached **Topographic Map "A"**

To reach Newfield Production Company well location site Ute Tribal 4-8-5-2E located in the SW¼ SE¼ Section 6, T5S, R2E, S.L.B. & M., Uintah County, Utah:

Proceed in a southeasterly direction out of Myton, approximately 16.9 miles to the junction of this road and an existing road to the northeast; proceed northeasterly approximately 8.2 miles to its junction with the beginning of the proposed access road to the northeast; proceed northeasterly along the proposed access road approximately 1,850'; turn and continue in a southeasterly direction along the proposed access road approximately 9,910' to the proposed well location.

The aforementioned dirt oil field service roads and other roads in the vicinity are constructed out of existing native materials that are prevalent to the existing area they are located in and range from clays to a sandy-clay shale material.

The roads for access during the drilling, completion and production phase will be maintained at the standards required by the State of Utah, or other controlling agencies. This maintenance will consist of some minor grader work for smoothing road surfaces and for snow removal. Any necessary fill material for repair will be purchase and hauled from private sources.

2. PLANNED ACCESS ROAD

The proposed well will be drilled directionally off of the Ute Tribal 5-8-5-2E well pad. See attached **Topographic Map "B"**.

3. LOCATION OF EXISTING WELLS

Refer to **EXHIBIT B**.

4. LOCATION OF EXISTING AND/OR PROPOSED FACILITIES

There are no existing facilities that will be used by this well.

It is anticipated that this well will be a producing oil well.

Upon construction of a tank battery, the well pad will be surrounded by a dike of sufficient capacity to contain at minimum 110% of the largest tank volume within the facility battery.

Tank batteries will be built to State specifications.

All permanent (on site for six (6) months or longer) structures, constructed or installed (including pumping units), will be painted a flat, non-reflective, earth tone color to match one of the standard

environmental colors, as determined by the Rocky Mountain Five State Interagency Committee. All facilities will be painted within six months of installation.

5. **LOCATION AND TYPE OF WATER SUPPLY**

Newfield Production will transport water by truck for drilling purposes from the following water sources:

Johnson Water District
Water Right: 43-10136

Neil Moon Pond
Water Right: 43-11787

Maurice Harvey Pond
Water Right: 47-1358

Newfield Collector Well
Water Right: 41-3530 (A30414DV, contracted with the Duchesne County Conservancy District).

There will be no water well drilled at this site.

6. **SOURCE OF CONSTRUCTION MATERIALS**

All construction material for this location shall be borrowed material accumulated during construction of the location site and access road.

A mineral material application is not required for this location.

7. **METHODS FOR HANDLING WASTE DISPOSAL**

A small reserve pit (90' x 40' x 8' deep, or less) will be constructed from native soil and clay materials. The reserve pit will receive the processed drill cutting (wet sand, shale & rock) removed from the wellbore. Any drilling fluids, which do accumulate in the pit as a result of shale-shaker carryover, cleaning of the sand trap, etc., will be promptly reclaimed. All drilling fluids will be fresh water based, typically containing Total Dissolved Solids of less than 3000 PPM. No potassium chloride, chromates, trash, debris, nor any other substance deemed hazardous will be placed in this pit. Therefore, it is proposed that no synthetic liner be required in the reserve pit. However, if upon constructing the pit there is insufficient fine clay and silt present, a liner will be used for the purpose of reducing water loss through percolation.

Newfield requests approval that a flare pit not be constructed or utilized on this location.

A portable toilet will be provided for human waste.

A trash basket will be provided for garbage (trash) and hauled away to an approved disposal site at the completion of the drilling activities.

Immediately upon first production, all produced water will be confined to a steel storage tank. If the production water meets quality guidelines, it is transported to the Ashley, Monument Butte, Jonah, and Beluga water injection facilities by company or contract trucks. Subsequently, the produced water is injected into approved Class II wells to enhance Newfield's secondary recovery project.

Water not meeting quality criteria, is disposed at Newfield's Pariette #4 disposal well (Sec. 7, T9S R19E) or at State of Utah approved surface disposal facilities.

8. **ANCILLARY FACILITIES:**

There are no ancillary facilities planned for at the present time and none foreseen in the near future.

9. **WELL SITE LAYOUT:**

See attached Location Layout Sheet.

Fencing Requirements

All pits will be fenced according to the following minimum standards:

- a) A 39-inch net wire shall be used with at least one strand of barbed wire on top of the net.
- b) The net wire shall be no more than two (2) inches above the ground. The barbed wire shall be three (3) inches above the net wire. Total height of the fence shall be at least forty-two (42) inches.
- c) Corner posts shall be centered and/or braced in such a manner to keep tight at all times
- d) Standard steel, wood or pipe posts shall be used between the corner braces. Maximum distance between any two posts shall be no greater than sixteen (16) feet.
- e) All wire shall be stretched, by using a stretching device, before it is attached to the corner posts.

The reserve pit fencing will be on three (3) sides during drilling operations and on the fourth side when the rig moves off location. Pits will be fenced and maintained until cleanup.

Existing fences to be crossed by the access road will be braced and tied off before cutting so as to prevent slacking in the wire. The opening shall be closed temporarily as necessary during construction to prevent the escape of livestock, and upon completion of construction the fence shall be repaired to BLM specifications.

10. **PLANS FOR RESTORATION OF SURFACE:**

a) **Producing Location**

Immediately upon well completion, the location and surrounding area will be cleared of all unused tubing, equipment, debris, material, trash and junk not required for production.

The reserve pit and that portion of the location not needed for production facilities/operations will be recontoured to the approximated natural contours. Weather permitting, the reserve pit will be reclaimed within one hundred twenty (120) days from the date of well completion. Before any dirt work takes place, the reserve pit must have all fluids and hydrocarbons removed.

b) **Dry Hole Abandoned Location**

At such time as the well is plugged and abandoned, the operator shall submit a subsequent report of abandonment and the State of Utah will attach the appropriate surface rehabilitation conditions of approval.

11. **SURFACE OWNERSHIP:** Ute Tribe (proposed location).

12. **OTHER ADDITIONAL INFORMATION:**

The Archaeological Resource Survey and Paleontological Resource Survey for this area are attached. MOAC Report #07-312, 9/7/07. Paleontological Resource Survey prepared by, SWCA, 9/10/07. See attached report cover pages, Exhibit "D".

Newfield Production Company requests 11,760' of disturbed area be granted to allow for construction of the planned access road. Refer to **Topographic Map "B"**. For the planned access road a temporary width of 60' will be needed for construction purposes with a permanent width of 30' and a running surface of 18'. The construction phase of the planned access road will last approximately (5) days. The planned access road will be an 18' crown road (9' either side of the centerline) with drainage ditches along either side of the proposed road whether it is deemed necessary in order to handle any run-off from normal meteorological conditions that are prevalent to this area. The maximum grade will be less than 8%. There will be no culverts required along this access road. There will be barrow ditches and turnouts as needed along this road. There are no fences encountered along this proposed road. There will be no new gates or cattle guards required. All construction material for this access road will be borrowed material accumulated during construction of the access road.

Newfield Production Company requests 11,760' of disturbed area be granted to allow for construction of the proposed surface gas lines. It is proposed that the disturbed area will temporarily be 50' wide to allow for construction of a 6" gas gathering line, and a 3" poly fuel gas line, with a permanent width of 30' upon completion of the proposed gas lines. The construction phase of the proposed gas lines will last approximately (5) days. Both lines will tie in to the existing pipeline infrastructure. Refer to Topographic Map "C."

- a) Newfield Production Company is responsible for informing all persons in the area who are associated with this project that they will be subject to prosecution for knowingly disturbing historic or archaeological sites, or for collecting artifacts. If historic or archaeological materials are uncovered during construction, Newfield is to immediately stop work that might further disturb such materials and contact the Authorized Officer.
- b) Newfield Production will control noxious weeds along rights-of-way for roads, pipelines, well sites or other applicable facilities. On State administered land it is required that a Pesticide Use Proposal shall be submitted and given approval prior to the application of herbicides or other possible hazardous chemicals.
- c) Drilling rigs and/or equipment used during drilling operations on this well site will not be stacked or stored on State Lands after the conclusion of drilling operations or at any other time without State authorization. However, if State authorization is obtained, it is only a temporary measure to allow time to make arrangements for permanent storage on commercial facilities.

Additional Surface Stipulations

All lease and/or unit operations will be conducted in such a manner that full compliance is made with all applicable laws and regulations, Onshore Oil and Gas Orders, the approved plan of operations and any applicable Notice to Lessees. A copy of these conditions will be furnished to the field representative to ensure compliance.

Hazardous Material Declaration

Newfield Production Company guarantees that during the drilling and completion of the Ute Tribal 4-8-5-2E, Newfield will not use, produce, store, transport or dispose 10,000# annually of any of the hazardous chemicals contained in the Environmental Protection Agency's consolidated list of chemicals subject to reporting under Title III Superfund Amendments and Reauthorization Act (SARA) of 1986. Newfield also guarantees that during the drilling and completion of the Ute Tribal 4-8-5-2E Newfield will use, produce, store, transport or dispose less than the threshold planning quantity (T.P.Q.) of any extremely hazardous substances as defined in 40 CFR 355.

A complete copy of the approved APD, if applicable, shall be on location during the construction of the location and drilling activities.

Newfield Production Company or a contractor employed by Newfield Production shall contact all required agencies, 48 hours prior to construction activities.

The BLM as well as the Ute Tribe Energy and Mineral Department shall be notified upon site completion prior to moving on the drilling rig.

13. **LESSEE'S OR OPERATOR'S REPRESENTATIVE AND CERTIFICATION:**

Representative


Name: Kim Kettle
Address: Newfield Production Company
Route 3, Box 3630
Myton, UT 84052
Telephone: (435) 646-3721

Certification

Please be advised that Newfield Production Company is considered to be the operator of well #4-8-5-2E, SW/NW Section 8, T5S, R2E, Uintah County, Utah and is responsible under the terms and conditions of the lease for the operations conducted upon the leased lands. Bond coverage is provided by US Specialty Insurance #B002792.

I hereby certify that the proposed drill site and access route have been inspected, and I am familiar with the conditions which currently exist; that the statements made in this plan are true and correct to the best of my knowledge; and that the work associated with the operations proposed here will be performed by Newfield Production Company and its contractors and subcontractors in conformity with this plan and the terms and conditions under which it is approved. This statement is subject to the provisions of the 18 U.S.C. 1001 for the filing of a false statement.

10/12/07
Date

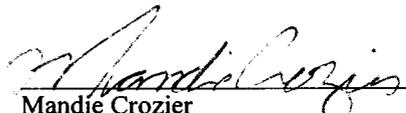
Mandie Crozier
Regulatory Specialist
Newfield Production Company

Newfield Production Corporation Proposed Site Facility Diagram


Ute Tribal 4-8-5-2E

From the Ute Tribal 5-8-5-2E Location

SW/NW Sec. 8 T5S, R2E

Uintah County, Utah

20G0005609

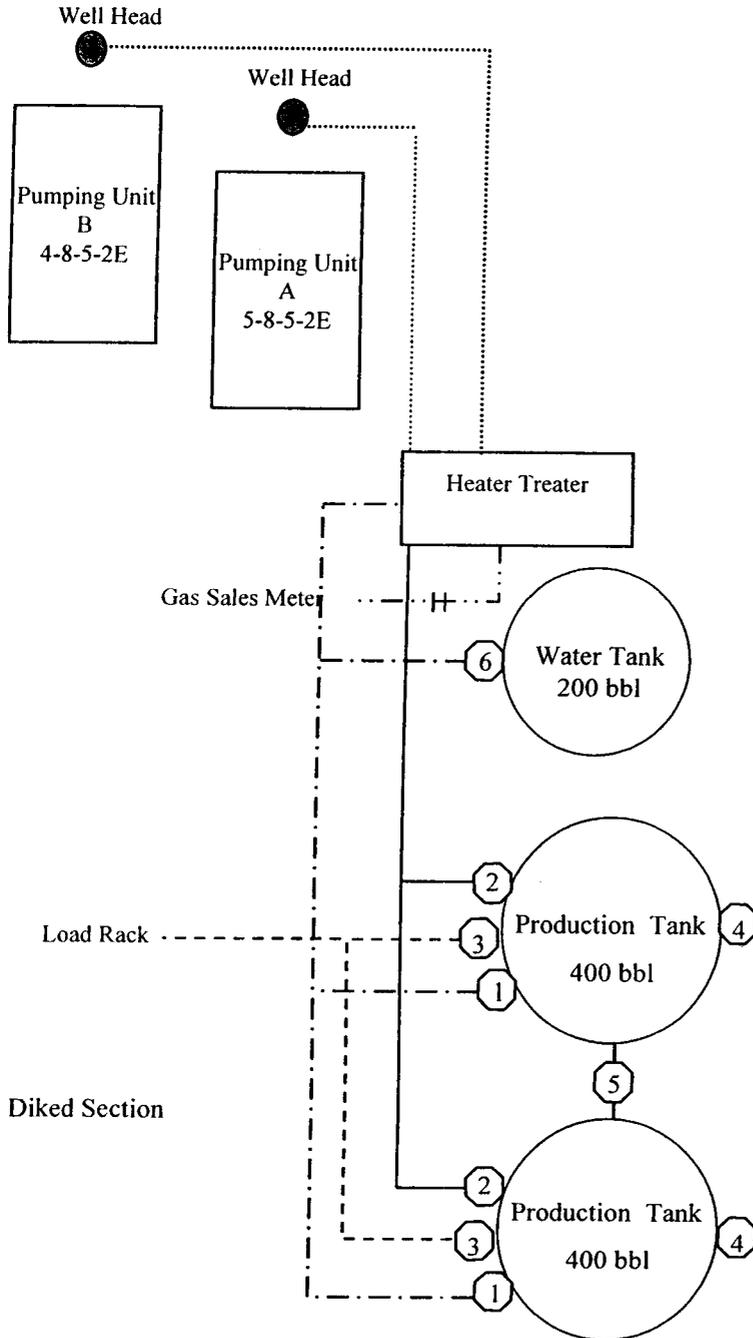

Site Security Plan is held at the Pleasant Valley Office, Duchesne County, Utah

Production Phase:

- 1) Valves 1, 3, and 4 sealed closed
- 2) Valves 2, 5, and 6 sealed open

Sales Phase:

- 1) Valves 1, 2, 4, 5, and 6 sealed closed
- 2) Valve 3 open

Draining Phase:

- 1) Valves 1 and 6 open

Legend

Emulsion Line
Load Rack	-----
Water Line	- . - . - .
Gas Sales	- . - . - .
Oil Line	—————


NEWFIELD PRODUCTION COMPANY

WELL PAD INTERFERENCE PLAT

UTE TRIBAL 5-8-5-2 (Proposed Well)

UTE TRIBAL 4-8-5-2 (Proposed Well)

Pad Location: SWNW Section 8, T5S, R2E, U.S.B.&M.

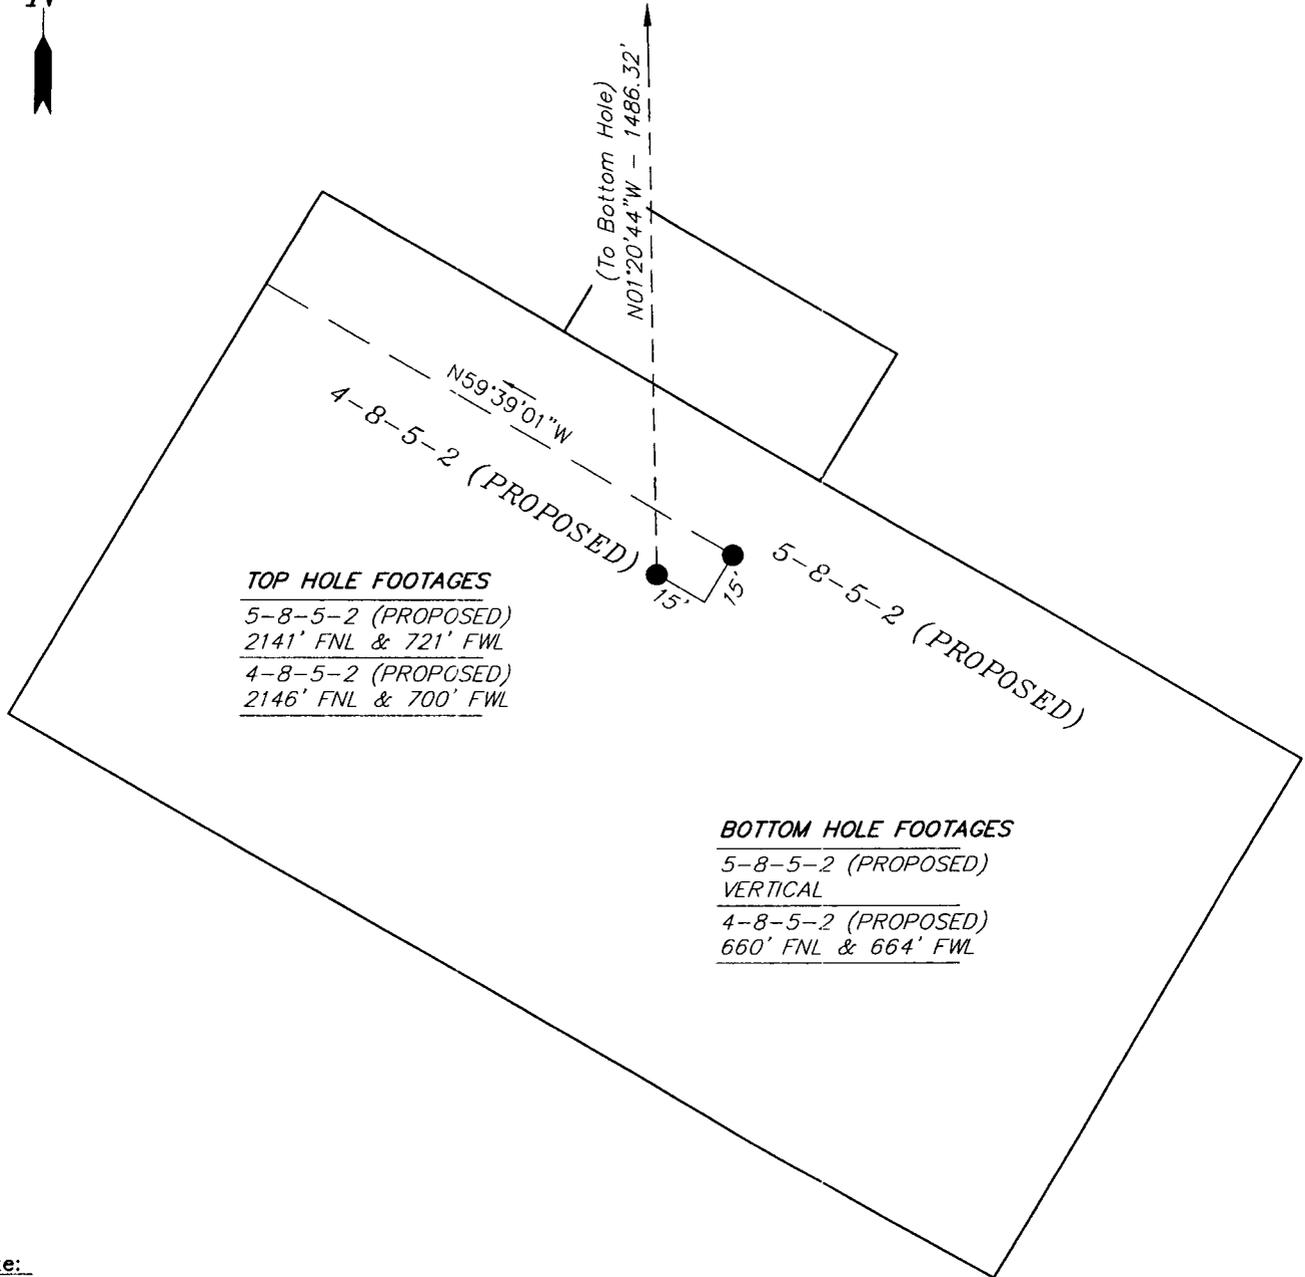

TOP HOLE FOOTAGES

5-8-5-2 (PROPOSED)
2141' FNL & 721' FWL

4-8-5-2 (PROPOSED)
2146' FNL & 700' FWL

BOTTOM HOLE FOOTAGES

5-8-5-2 (PROPOSED)
VERTICAL

4-8-5-2 (PROPOSED)
660' FNL & 664' FWL

Note:

Bearings are based on G.P.S. observations.

RELATIVE COORDINATES
From top hole to bottom hole

WELL	NORTH	EAST
4-8-5-2	1,486'	-35'

LATITUDE & LONGITUDE
Surface position of Wells (NAD 83)

WELL	LATITUDE	LONGITUDE
5-8-5-2	40° 03' 55.42"	109° 47' 58.89"
4-8-5-2	40° 03' 55.37"	109° 47' 59.16"

SURVEYED BY: C.M.	DATE SURVEYED: 09-06-07
DRAWN BY: F.T.M.	DATE DRAWN: 09-07-07
SCALE: 1" = 50'	REVISED:


Tri State (435) 781-2501
Land Surveying, Inc.
180 NORTH VERNAL AVE. VERNAL, UTAH 84078

NEWFIELD PRODUCTION COMPANY

UTE TRIBAL 5-8-5-2 (Proposed Well)

UTE TRIBAL 4-8-5-2 (Proposed Well)

Pad Location: SWNW Section 8, T5S, R2E, U.S.B.&M.

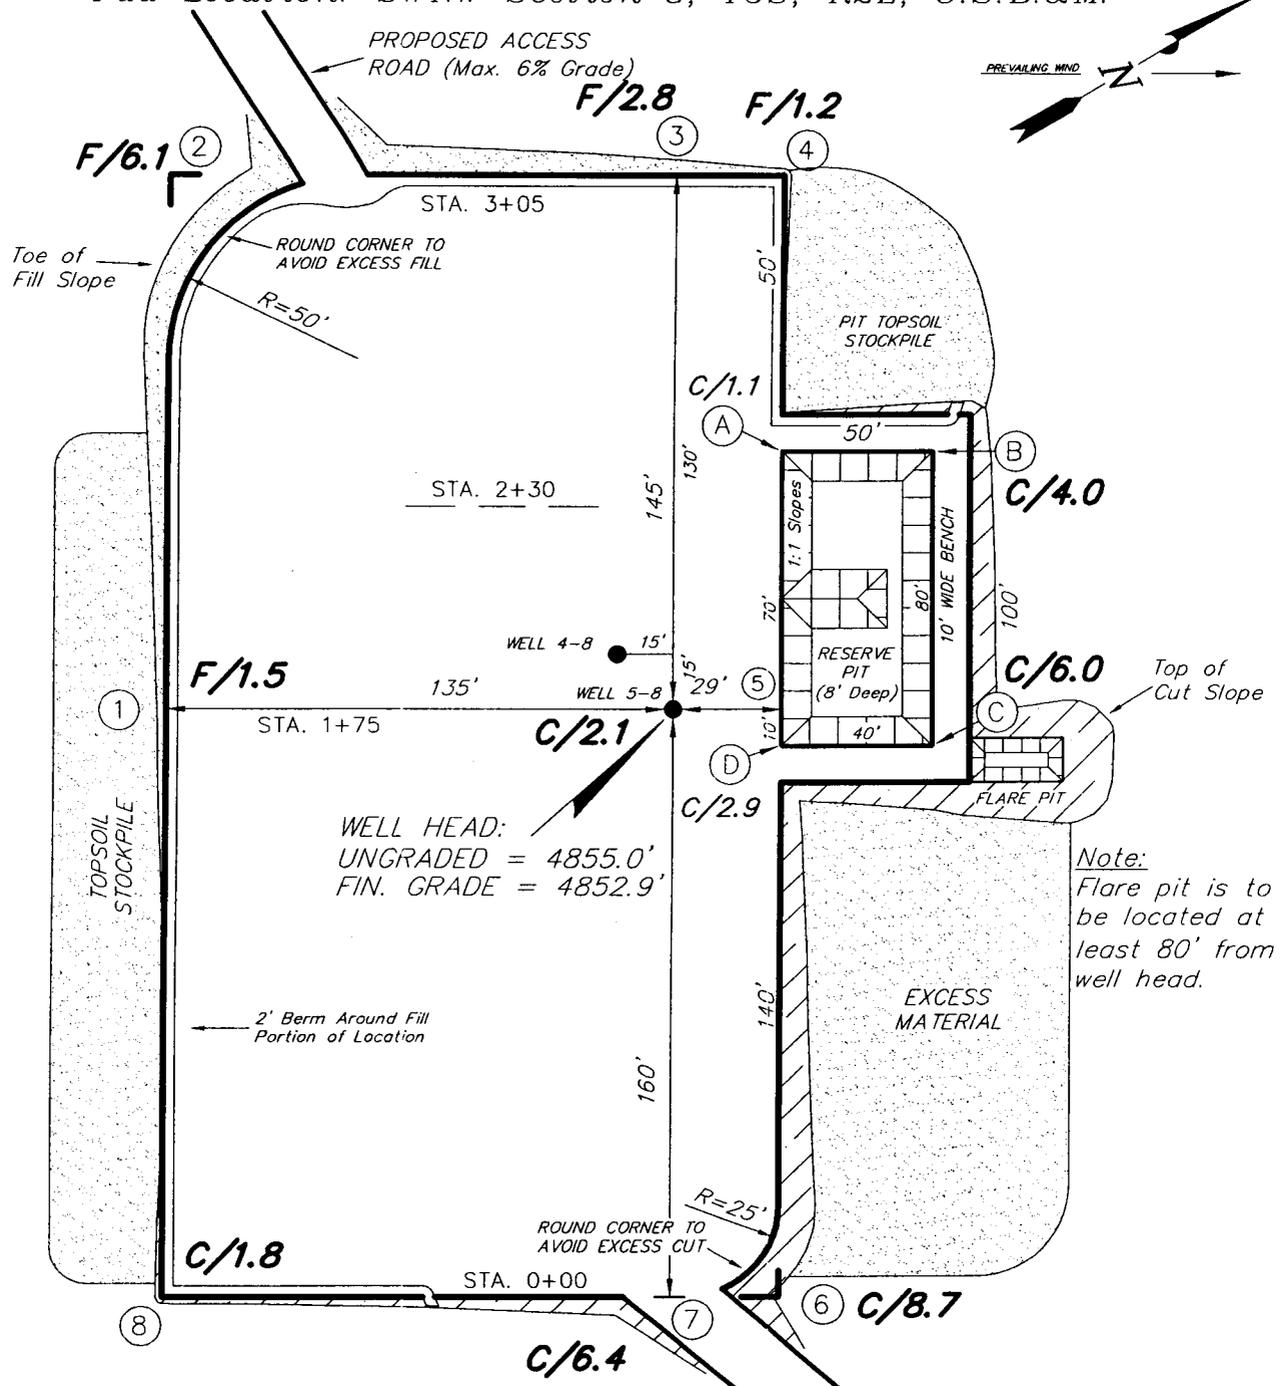

Note:
Flare pit is to be located at least 80' from well head.

REFERENCE POINTS

- 185' SOUTHWEST = 4849.9'
- 235' SOUTHWEST = 4850.4'
- 195' NORTHWEST = 4848.5'
- 245' NORTHWEST = 4848.2'

PROPOSED ACCESS ROAD (Max. 6% Grade)

SURVEYED BY: C.M.	DATE SURVEYED: 09-06-07	
DRAWN BY: F.T.M.	DATE DRAWN: 09-07-07	
SCALE: 1" = 50'	REVISED:	

Tri State
Land Surveying, Inc.

180 NORTH VERNAL AVE. VERNAL, UTAH 84078





(435) 781-2501

NEWFIELD PRODUCTION COMPANY

CROSS SECTIONS

UTE TRIBAL 5-8-5-2 (Proposed Well)

UTE TRIBAL 4-8-5-2 (Proposed Well)

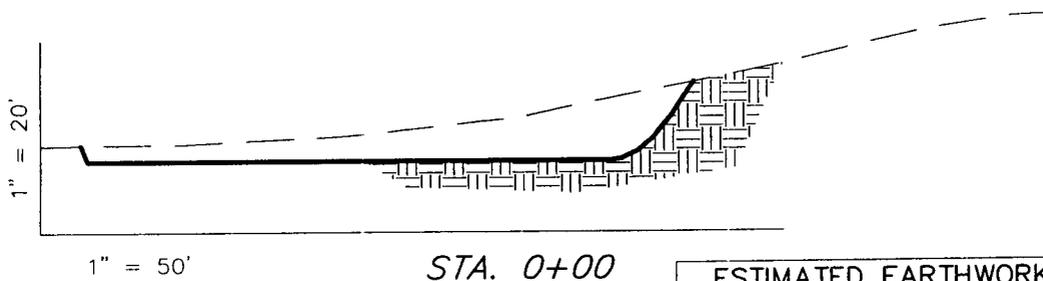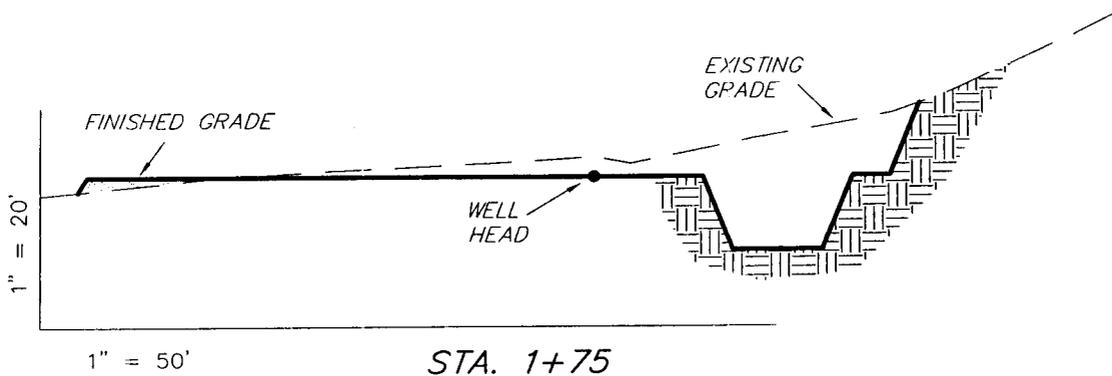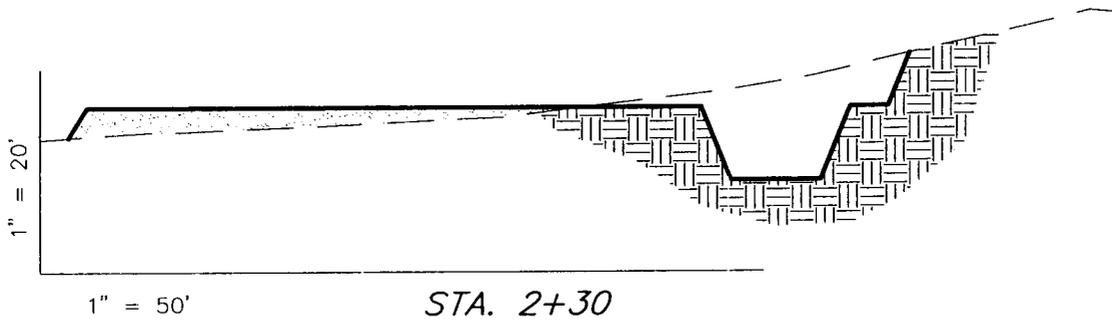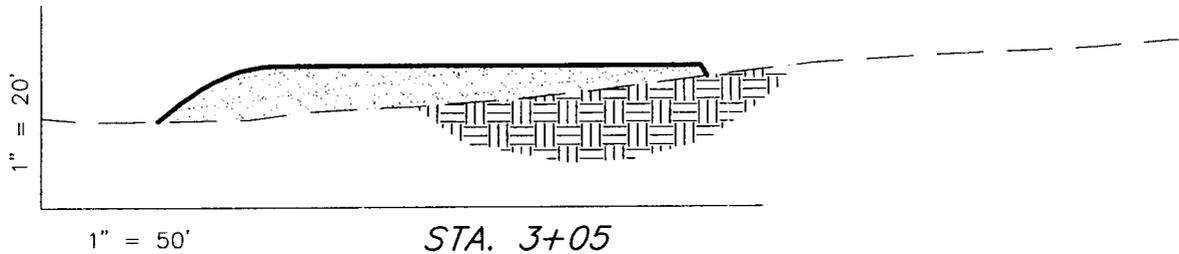

NOTE:
UNLESS OTHERWISE NOTED
CUT SLOPES ARE AT 1:1
FILL SLOPES ARE AT 1.5:1

ESTIMATED EARTHWORK QUANTITIES
(No Shrink or swell adjustments have been used)
(Expressed in Cubic Yards)

ITEM	CUT	FILL	6" TOPSOIL	EXCESS
PAD	3,540	2,280	Topsoil is not included in Pad Cut	1,260
PIT	640	0		640
TOTALS	4,180	2,280	1,110	1,900

SURVEYED BY: C.M.	DATE SURVEYED: 09-06-07
DRAWN BY: F.T.M.	DATE DRAWN: 09-07-07
SCALE: 1" = 50'	REVISED:


Tri State
Land Surveying, Inc. (435) 781-2501
180 NORTH VERNAL AVE. VERNAL, UTAH 84078

NEWFIELD PRODUCTION COMPANY

TYPICAL RIG LAYOUT


UTE TRIBAL 5-8-5-2 (Proposed Well)

UTE TRIBAL 4-8-5-2 (Proposed Well)

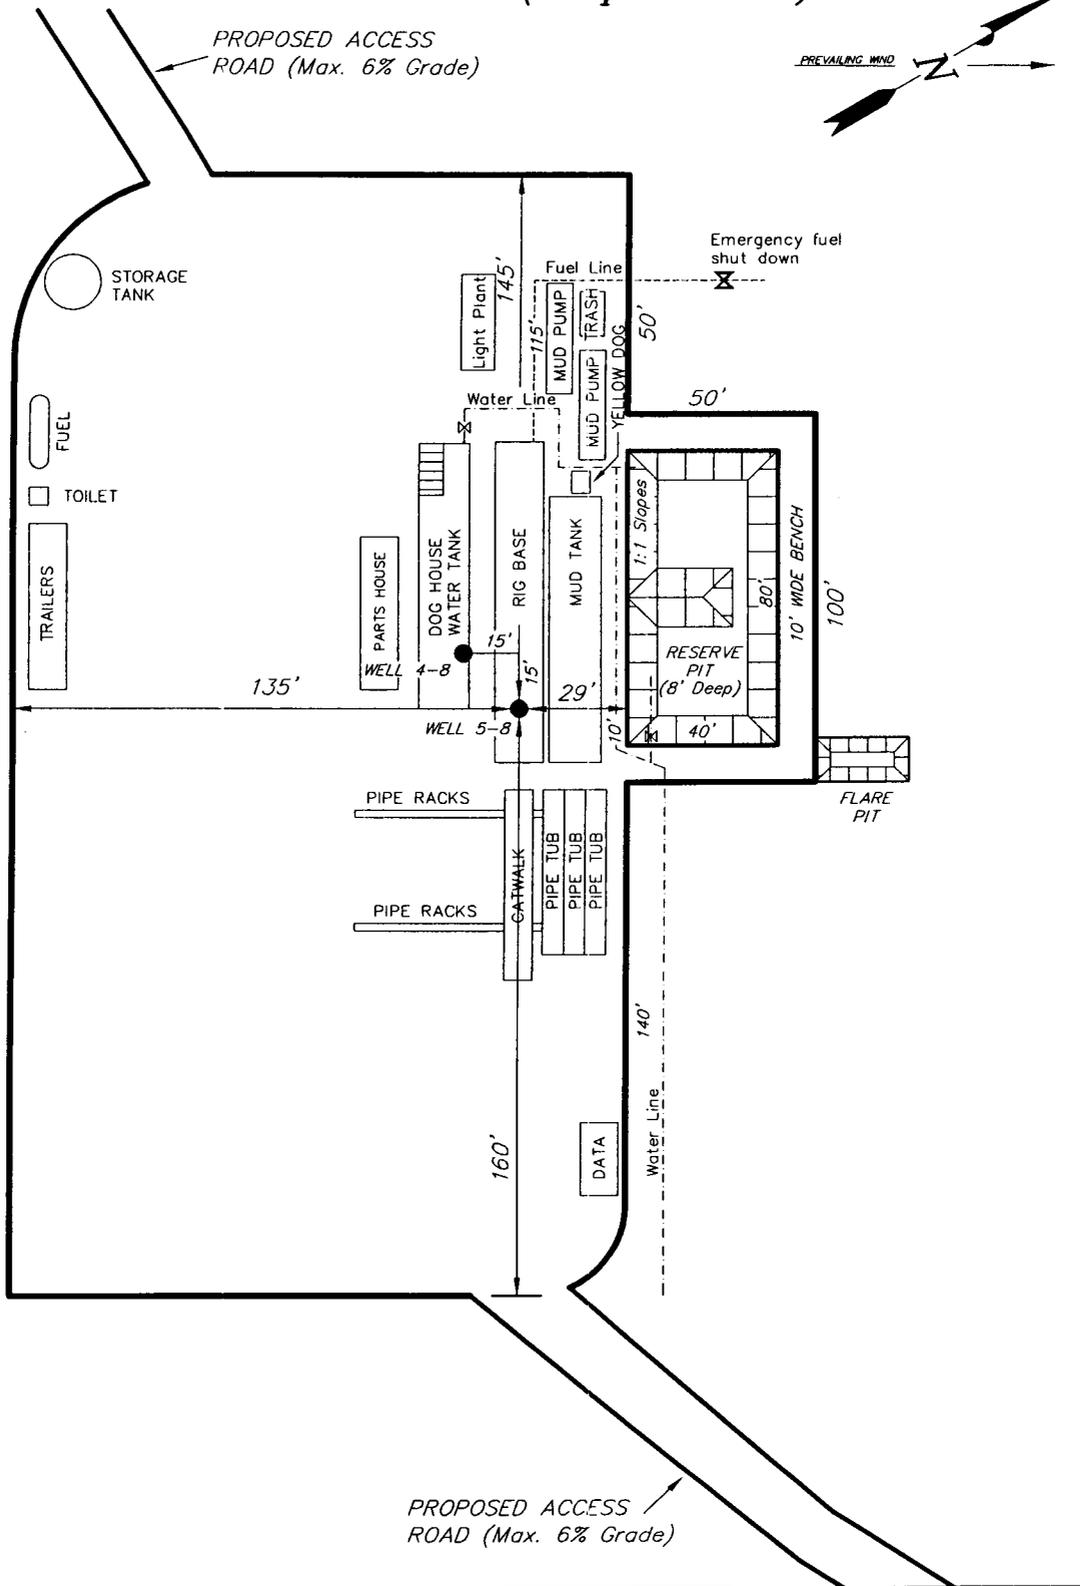

SURVEYED BY: C.M.	DATE SURVEYED: 09-06-07
DRAWN BY: F.T.M.	DATE DRAWN: 09-07-07
SCALE: 1" = 50'	REVISED:

Tri State (435) 781-2501
 Land Surveying, Inc.
 180 NORTH VERNAL AVE. VERNAL, UTAH 84078

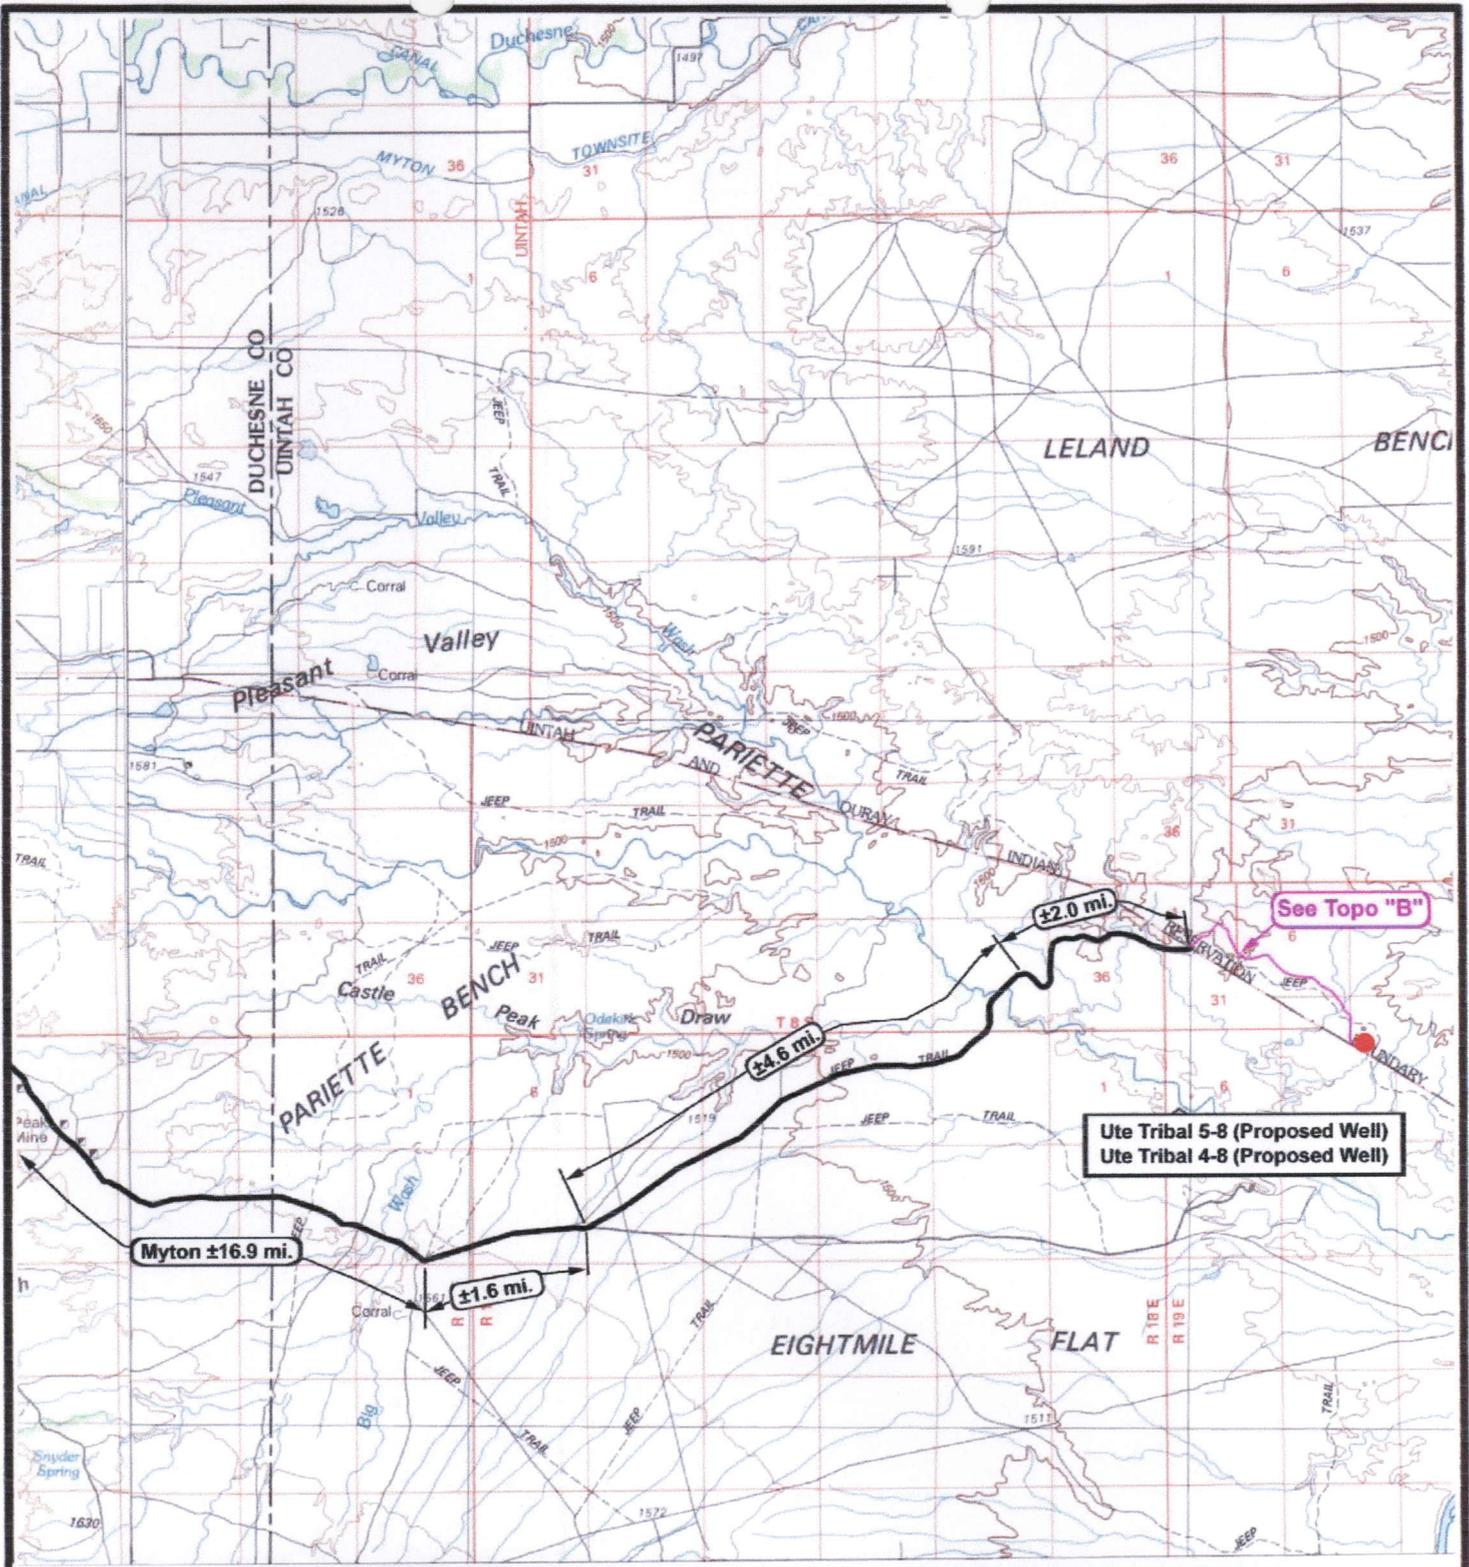

NEWFIELD
Exploration Company

Ute Tribal 5-8-5-2 (Proposed Well)
Ute Tribal 4-8-5-2 (Proposed Well)
Pad Location: SWNW SEC. 8, T5S, R2E, U.S.B.&M.




Tri-State
Land Surveying Inc.
(435) 781-2501
180 North Vernal Ave. Vernal, Utah 84078

SCALE: 1 = 100,000
DRAWN BY: mw
DATE: 10-17-2007

Legend

- Existing Road
- Proposed Access

TOPOGRAPHIC MAP
"A"

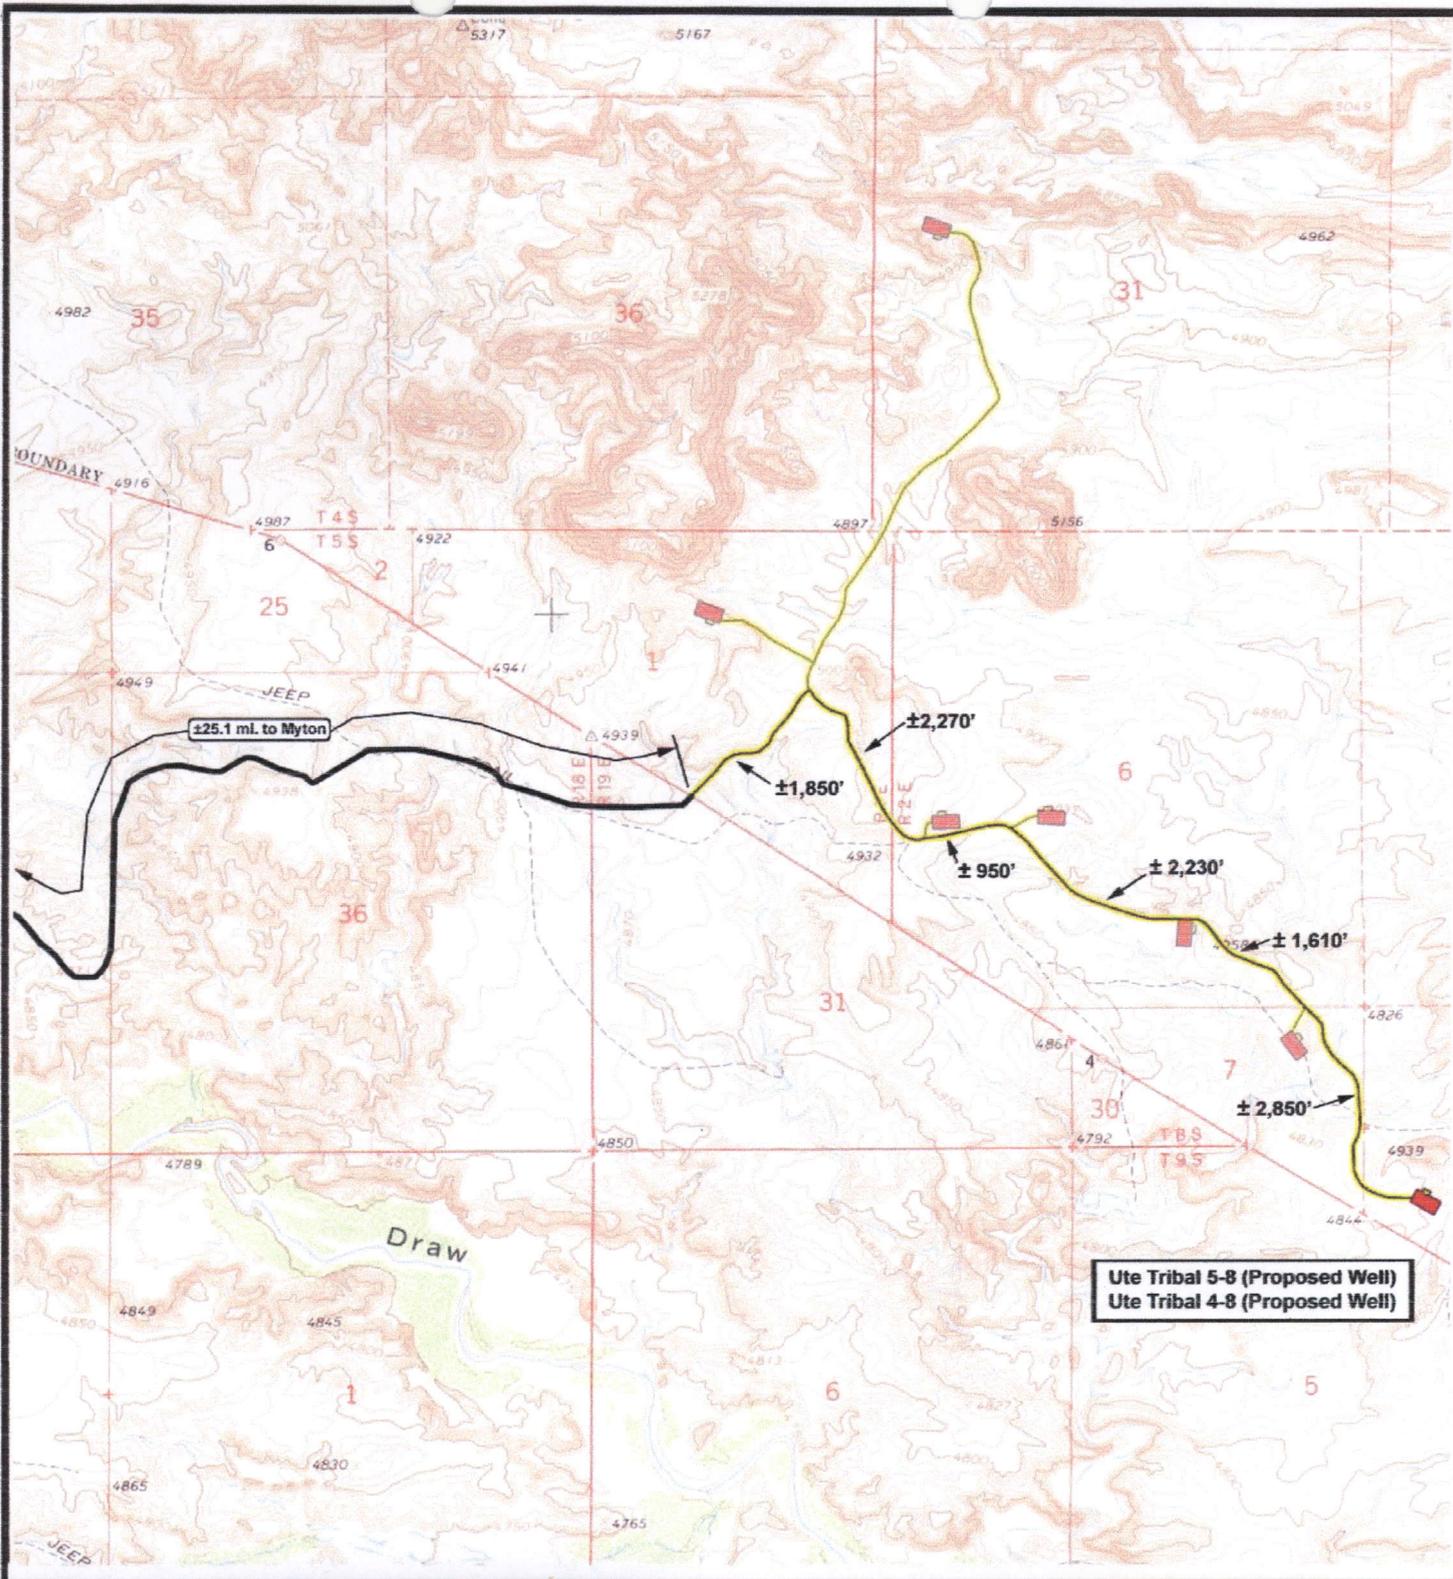

NEWFIELD
Exploration Company

Ute Tribal 5-8-5-2 (Proposed Well)
Ute Tribal 4-8-5-2 (Proposed Well)
Pad Location: SWNW SEC. 8, T5S, R2E, U.S.B.&M.



Tri-State
Land Surveying Inc.
(435) 781-2501
190 North Vernal Ave. Vernal, Utah 84078


SCALE: 1" = 2,000'
DRAWN BY: mw
DATE: 10-17-2007

Legend

- Existing Road
- Proposed Access

TOPOGRAPHIC MAP

"B"

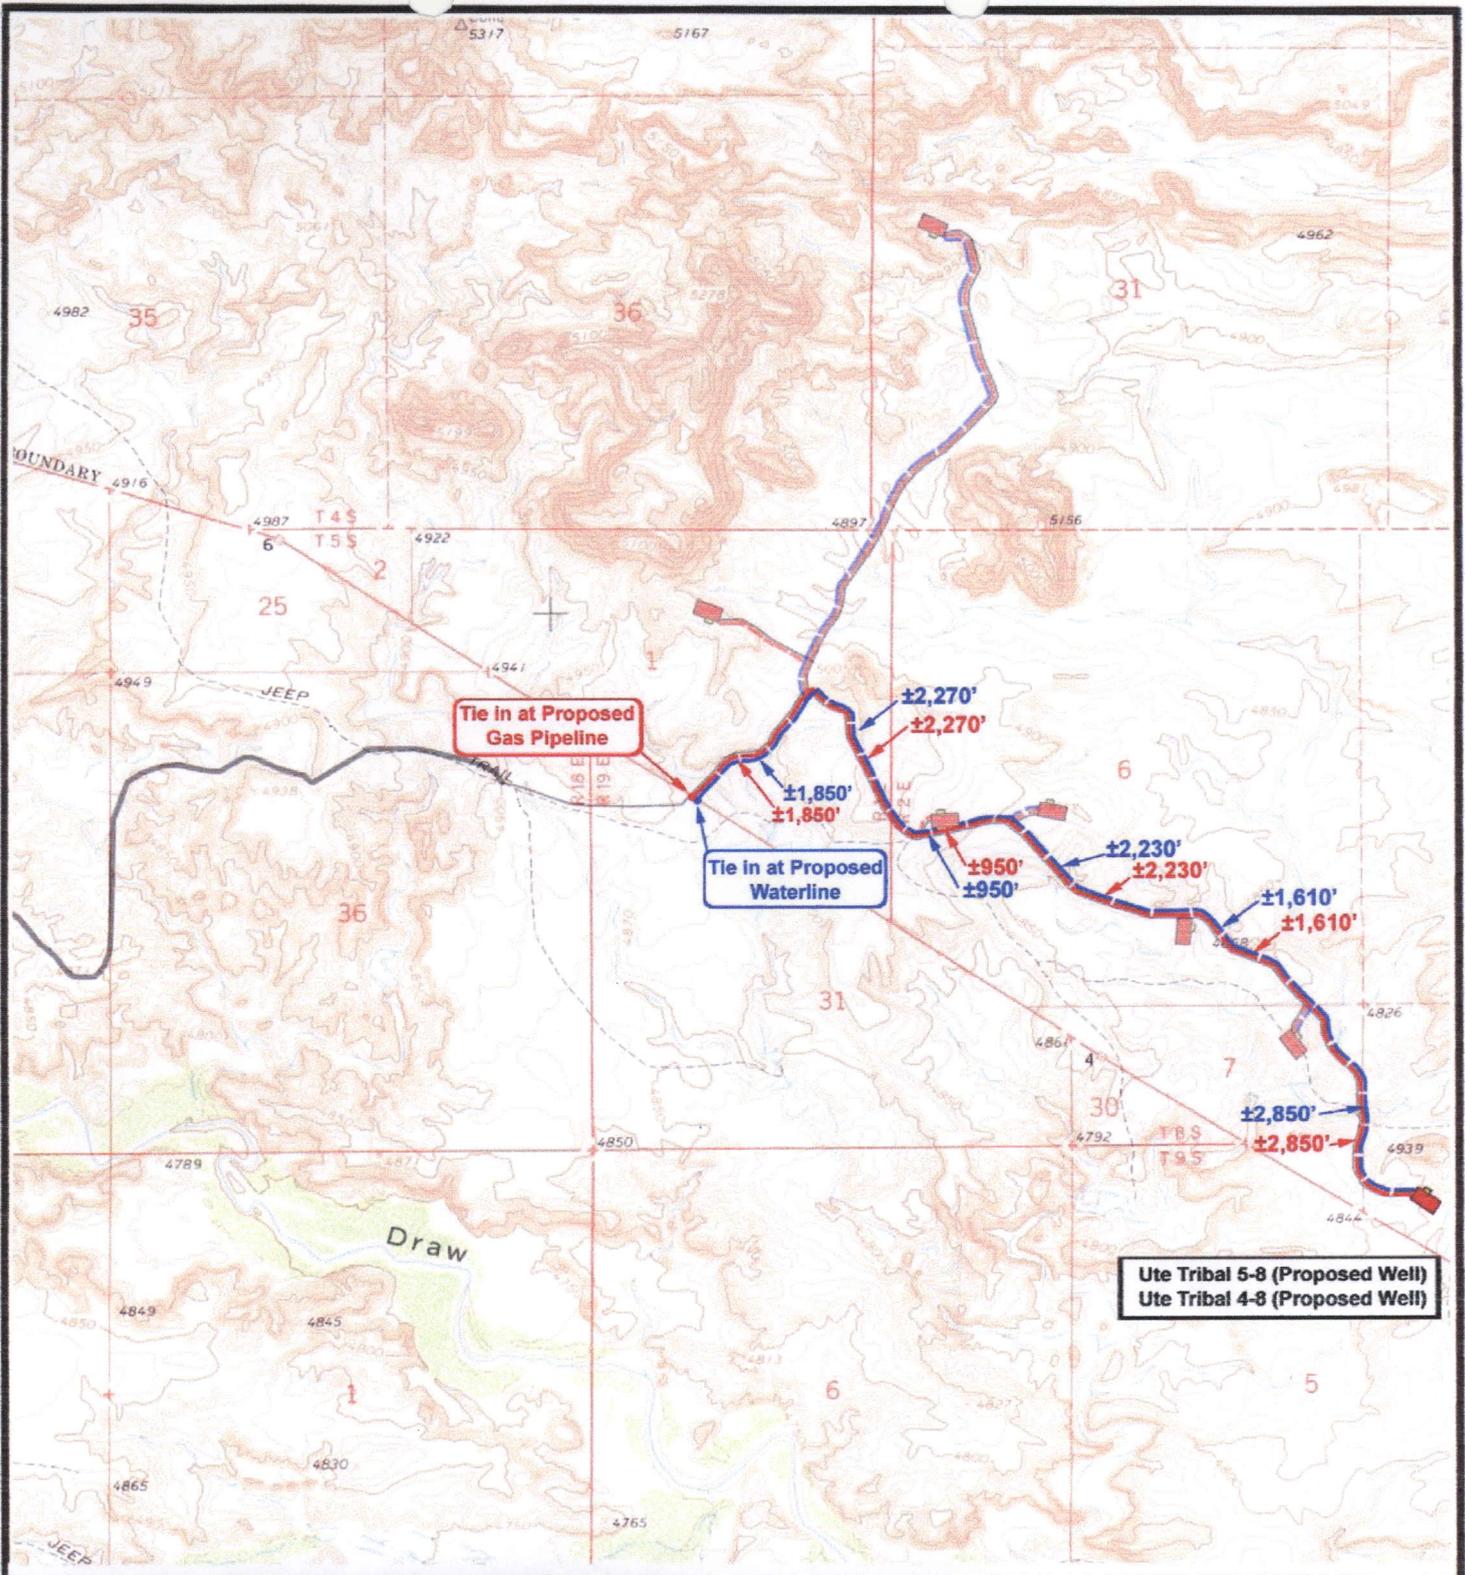

NEWFIELD
Exploration Company

Ute Tribal 5-8-5-2 (Proposed Well)
Ute Tribal 4-8-5-2 (Proposed Well)
Pad Location: SWNW SEC. 8, T5S, R2E, U.S.B.&M.

Tri-State
Land Surveying Inc.
(435) 781-2501
180 North Vernal Ave. Vernal, Utah 84078


SCALE: 1" = 2,000'
DRAWN BY: mw
DATE: 10-17-2007

Legend

- Roads
- Proposed Gas Line
- Proposed Water Line

TOPOGRAPHIC MAP

"C"

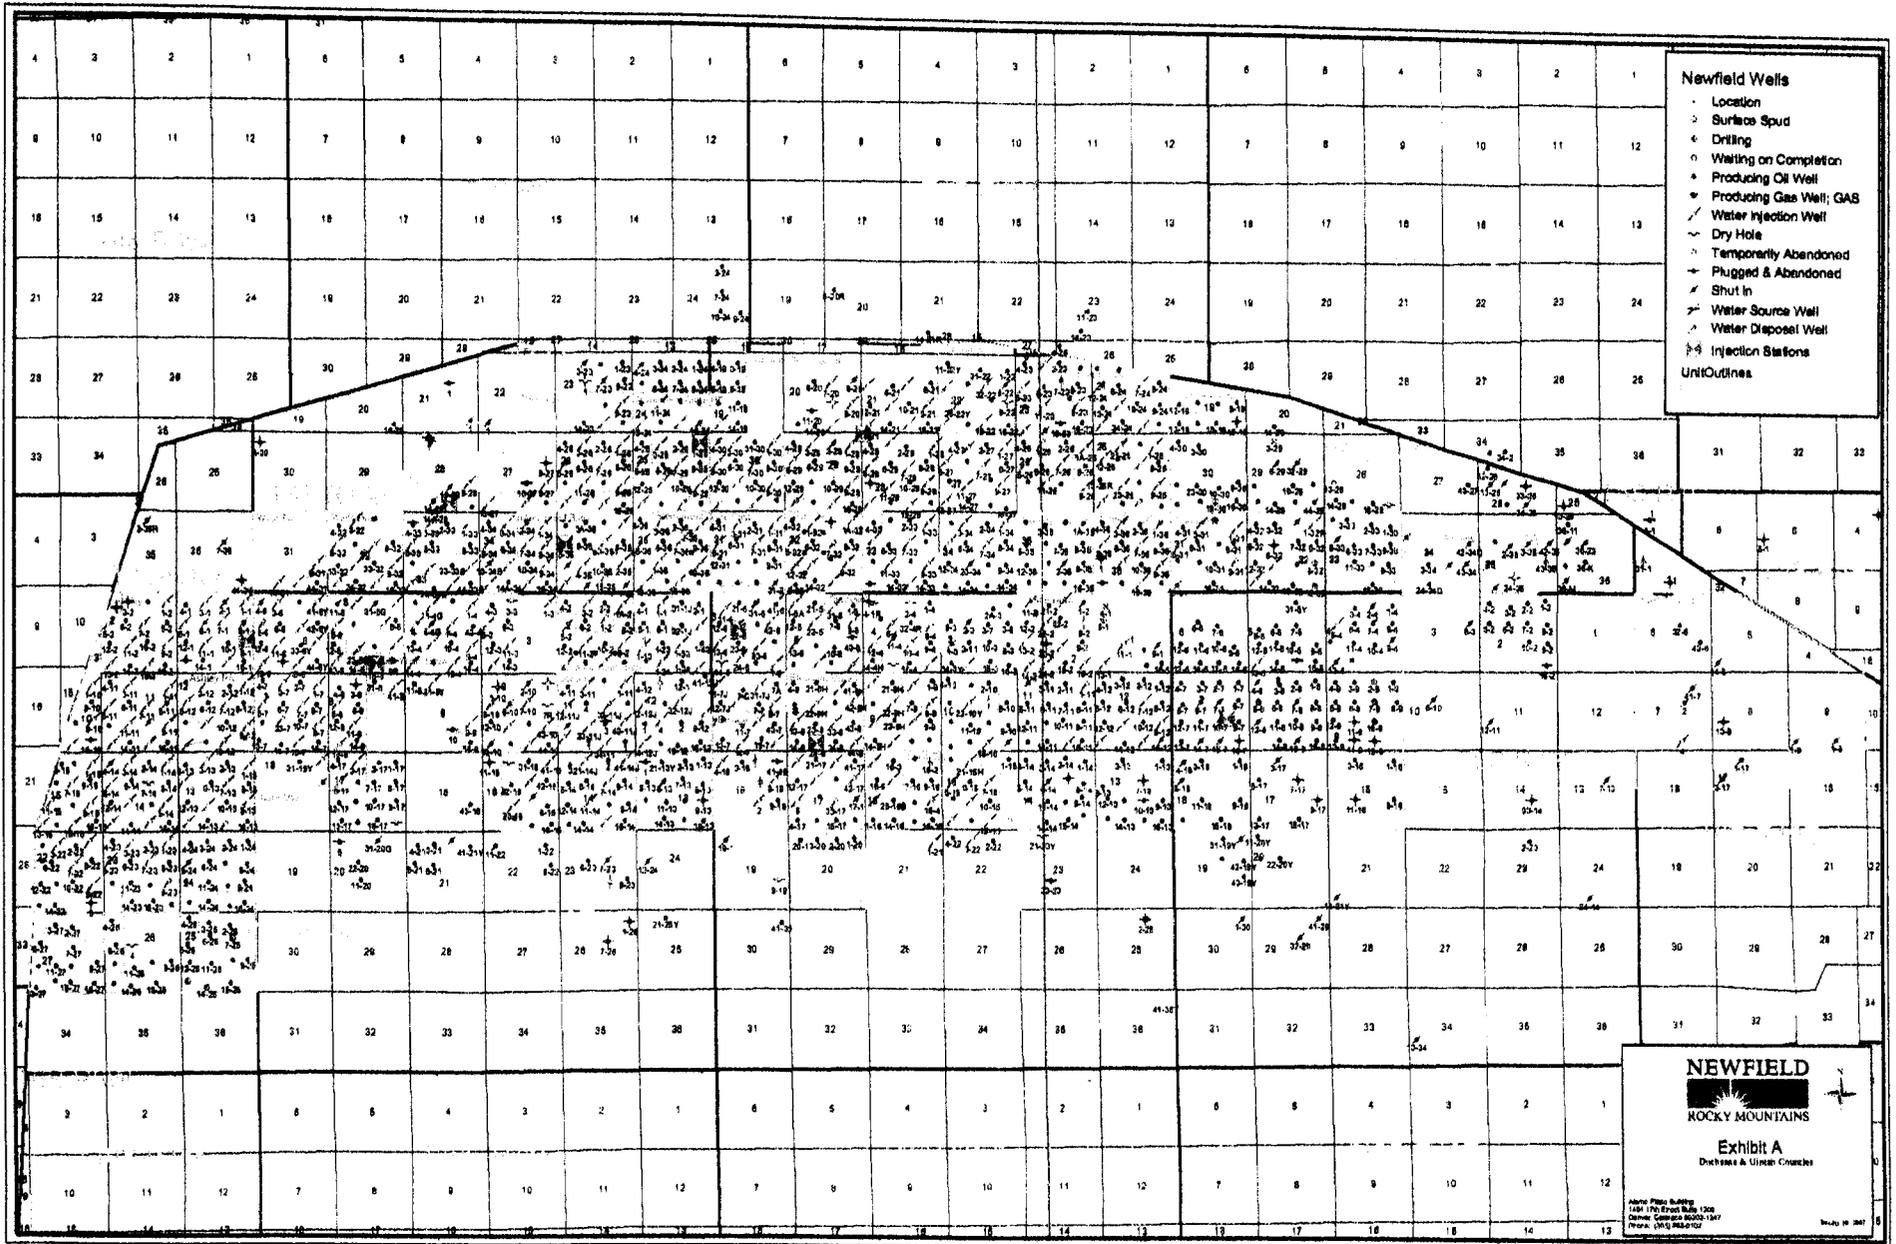


- Newfield Wells**
- Location
 - Surface Spud
 - ◊ Drilling
 - ◊ Waiting on Completion
 - ◊ Producing Oil Well
 - ◊ Producing Gas Well; GAS
 - ◊ Water Injection Well
 - ◊ Dry Hole
 - ◊ Temporarily Abandoned
 - ◊ Plugged & Abandoned
 - ◊ Shut In
 - ◊ Water Source Well
 - ◊ Water Disposal Well
 - ◊ Injection Stations
- Unit Outlines

NEWFIELD
 ROCKY MOUNTAINS

Exhibit A
 Dishes & Upland Courts

Alpha Print Building
 1401 17th Street Suite 1500
 Denver, Colorado 80202-1447
 Phone: (303) 888-1022

Scale: 10' = 1" 2007

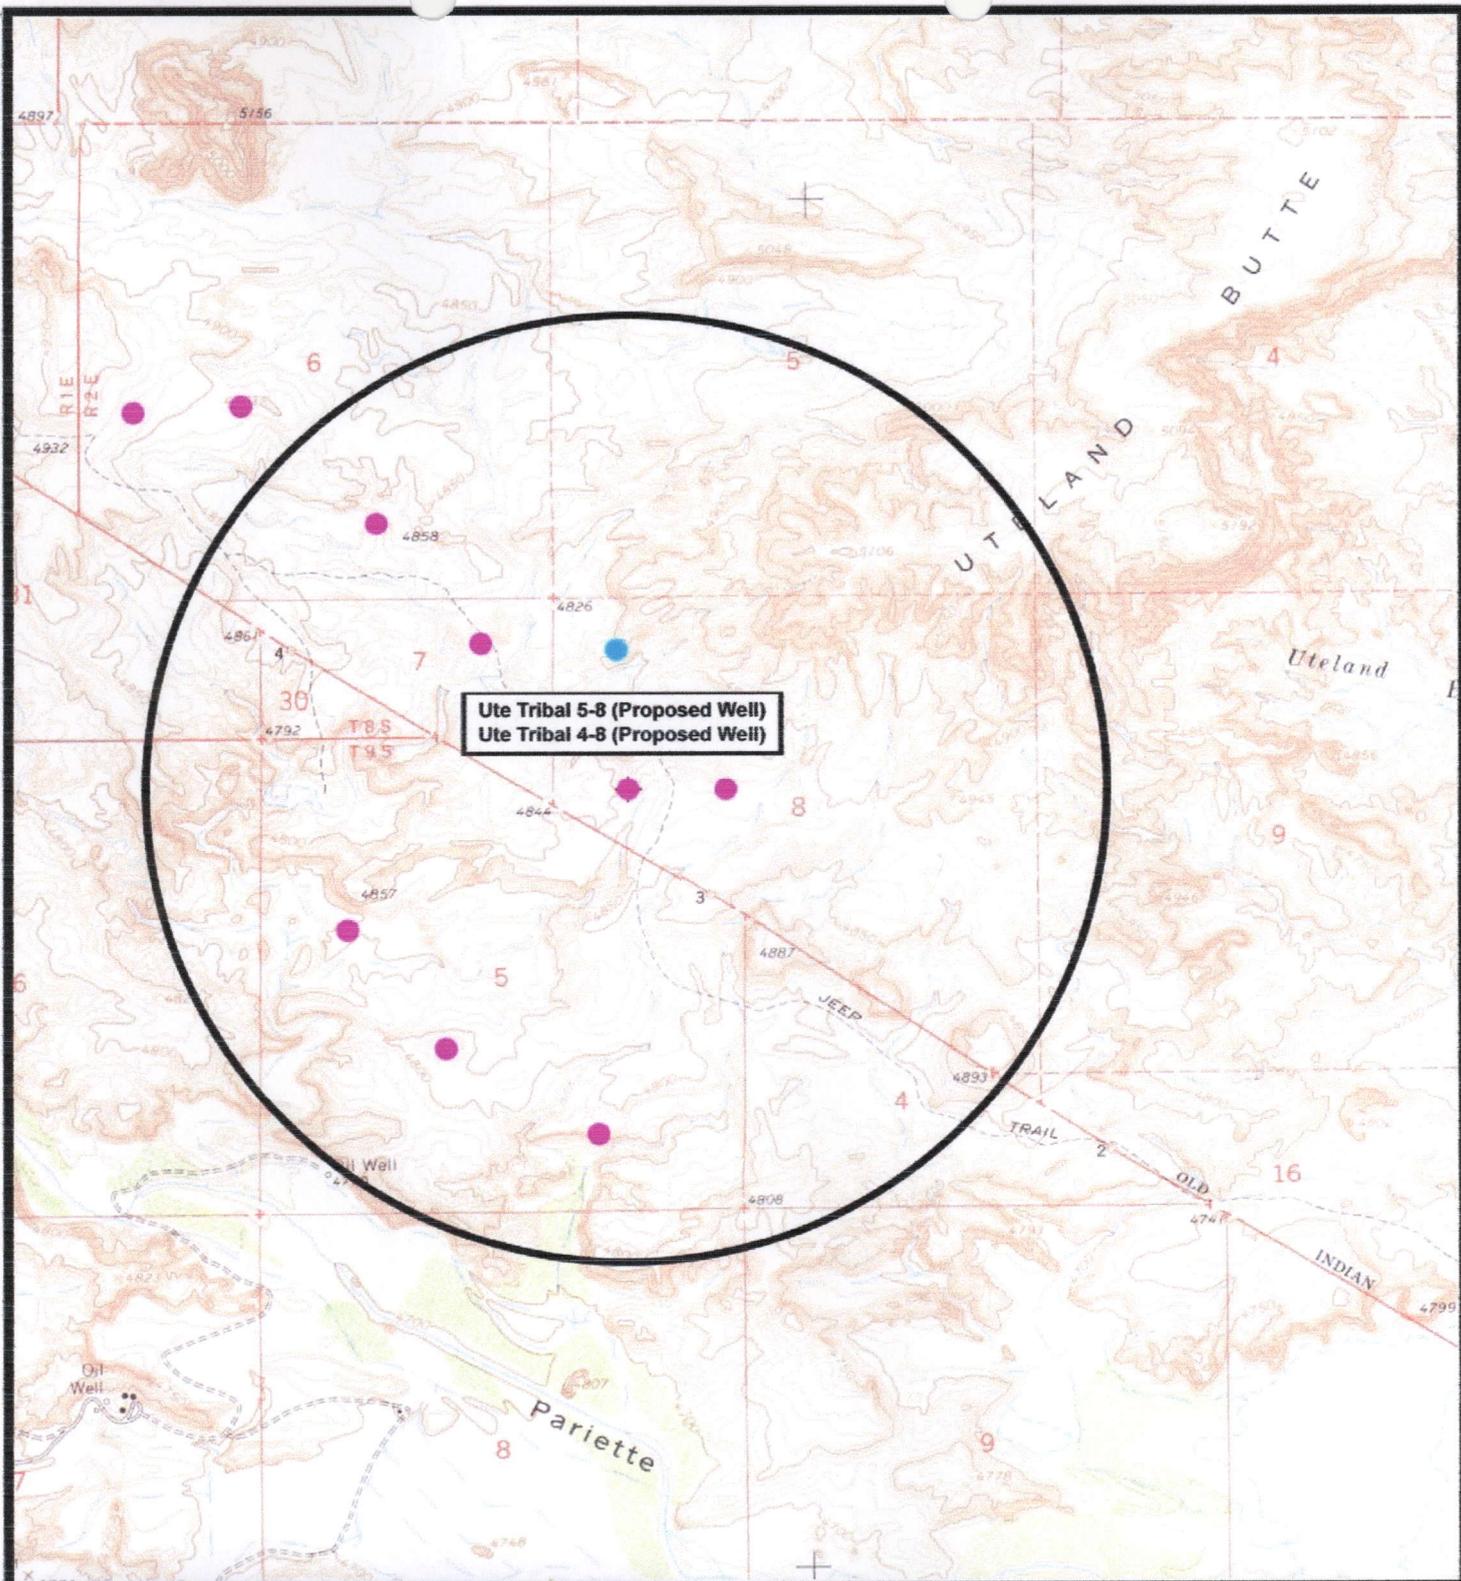



NEWFIELD
 Exploration Company

Ute Tribal 5-8-5-2 (Proposed Well)
Ute Tribal 4-8-5-2 (Proposed Well)
 Pad Location: SWNW SEC. 8, T5S, R2E, U.S.B.&M.




Tri-State
Land Surveying Inc.
 (435) 781-2501
 180 North Vernal Ave. Vernal, Utah 84078

SCALE: 1" = 2,000'
 DRAWN BY: mw
 DATE: 09-10-2007

Legend

- Pad Location
- Bottom Hole Location
- One-Mile Radius

Exhibit "B"

2-M SYSTEM

Blowout Prevention Equipment Systems

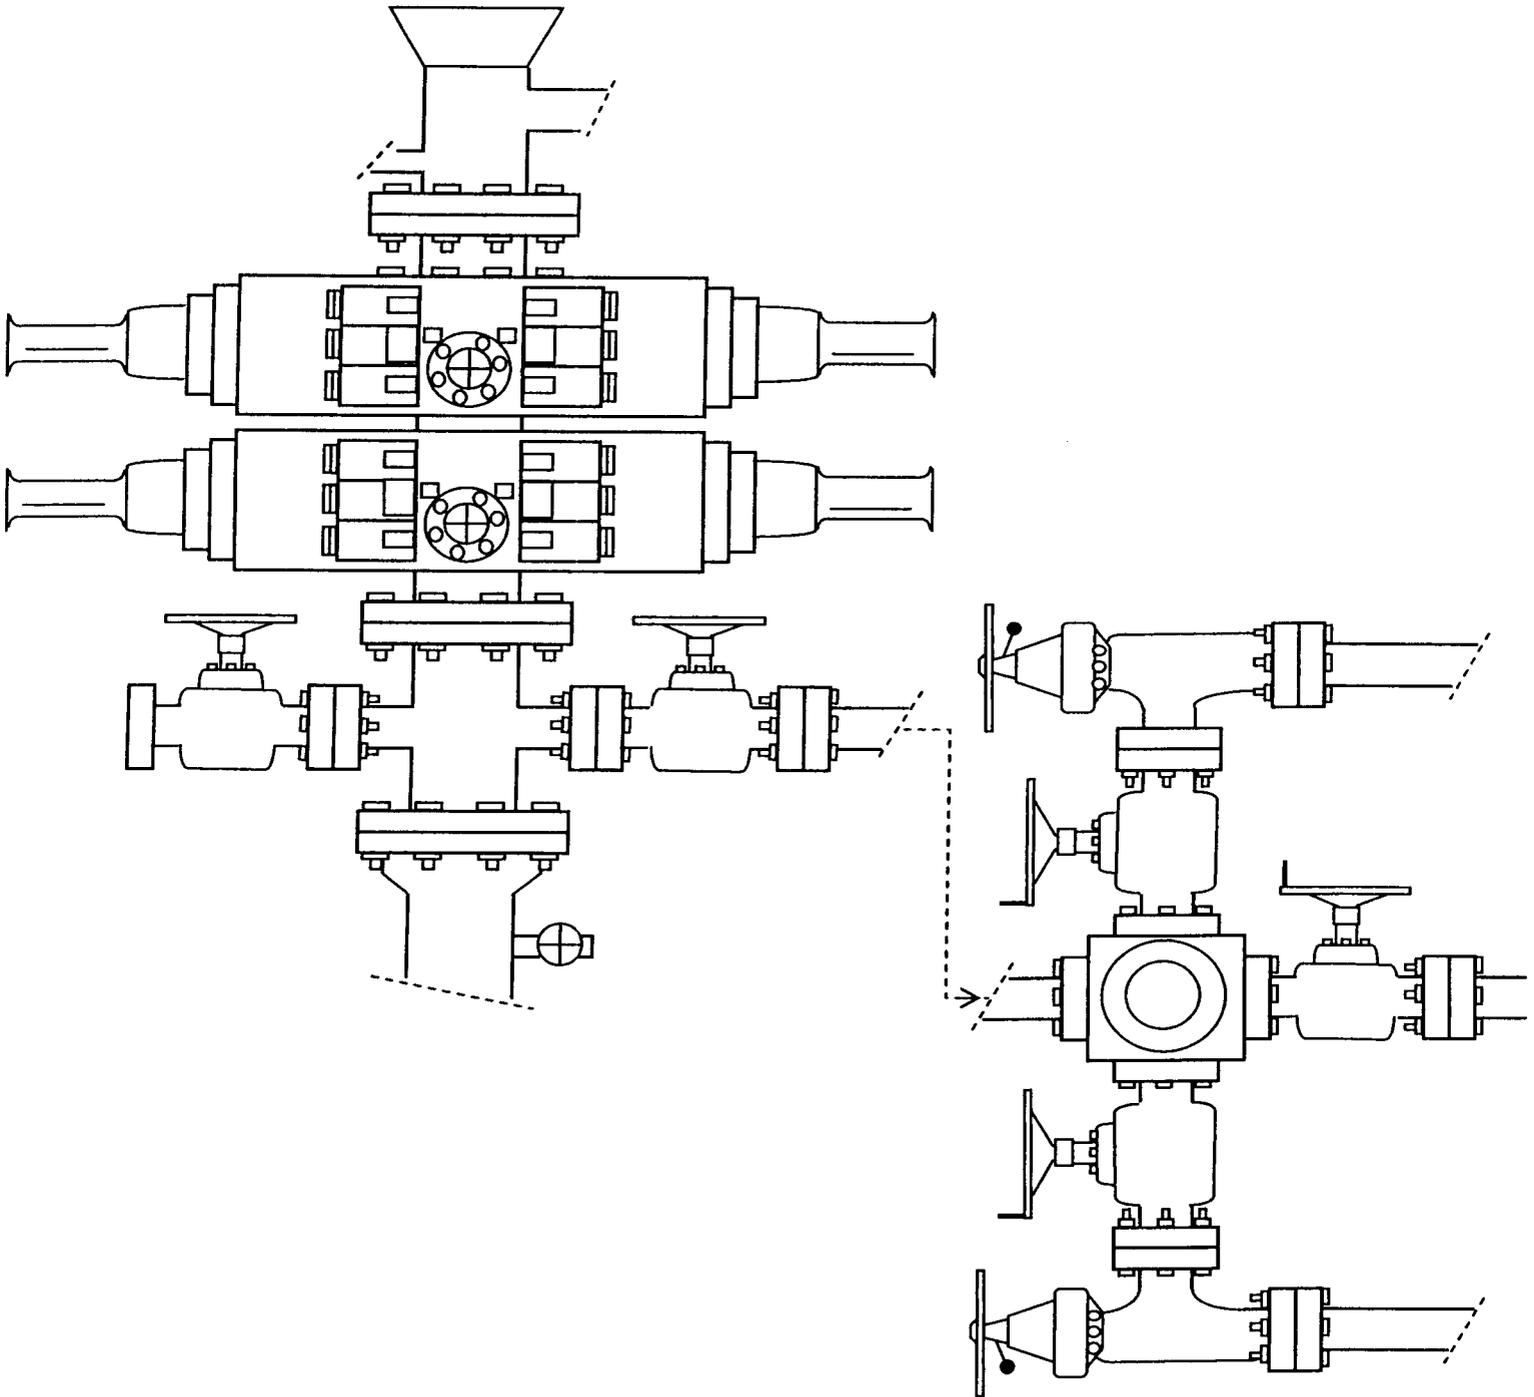


EXHIBIT C

CULTURAL RESOURCE INVENTORY OF
NEWFIELD EXPLORATION'S PROPOSED WELL LOCATIONS:
UTE TRIBAL #11-35-4-1E, #16-35-4-1E, #13-36-4-1E,
#2-1-5-1, #3-1-5-1, #4-1-5-1, #12-6-5-2, #15-6-5-2,
#2-7-5-2, #4-8-5-2, AND #5-8-5-2
UINTAH COUNTY, UTAH

By:

Jacki A. Montgomery

Prepared For:

State of Utah School and Institutional
Trust Lands Administration,
Bureau of Land Management
Vernal Field Office
and
Ute Indian Tribe
Uintah and Ouray Agency

Prepared Under Contract With:

Newfield Exploration Company
Rt. 3 Box 3630
Myton, UT 84052

Submitted By:

Montgomery Archaeological Consultants, Inc.
P.O. Box 219
Moab, Utah 84532

MOAC Report No. 07-312

September 7, 2007

United States Department of Interior (FLPMA)
Permit No. 07-UT-60122

State of Utah Public Lands Policy
Archaeological Survey Permit No. 117

State of Utah Antiquities Project (Survey)
Permit No. U-07-MQ-1103b,s,i,p

Ute Tribal Permit No. A07-363

250

**Paleontological Assessment Preliminary
Report for Newfield Wells 5-8-5S-2E and
4-8-5S-2E (directional) and Associated
Infrastructure**

**Uteland Butte Quad
Uintah County, Utah**

Prepared for

**Newfield Exploration Company
and
Ute Indian Tribe**

Prepared by

SWCA Environmental Consultants

September 10, 2007



UTE INDIAN TRIBE

Energy and Minerals Department

P.O. Box 70

988 South 7500 East

Fort Duchesne, Utah 84026

September 17, 2007

Phone: 435-725-4950

Fax: 435-725-4970

Email: energy_minerals@utetribe.com

Mr. Gil Hunt, Director, Oil & Gas
Utah Division of Oil, Gas and Mining
P.O. Box 145801
Salt Lake City, Utah 84114-5801

Re: Newfield Production Company Exception Locations – Monument Buttes

Gentleman:

Due to topographic or environmental situations, Newfield has had to stake certain obligation wells for 2007 in areas that require an exception location approval from the Utah Division of Oil, Gas & Mining along with Tribal concurrence for same.

Attached are twelve (12) letters, along with accompanying support data, from Newfield to the Tribe requesting Tribal consent for twelve (12) exception locations. The twelve (12) exception locations requiring Tribal consent are as follows: Ute Tribal 10-21-4-1, 9-20-4-1, 8-25-4-1, 6-25-4-1, 2-1-5-1, 4-1-5-1, 3-1-5-1, 7-19-4-1, 7-23-4-1, 16-35-4-1, 4-8-5-2 and the 2-7-5-2.

Pursuant to Tribal Business Committee Resolution 06-217 dated October 25, 2006, the Tribe entered into an Exploration and Development Agreement with Newfield Production Company effective February 23, 2007. Under this contract, Newfield is required to drill twelve (12) wells per year in order to meet its contractual obligations with the Tribe.

By this letter, the Tribe hereby consents to Newfield's proposed exception locations and requests that your Agency approve same.

Thank you for your consideration in this matter. If you have any questions or need any additional information, please contact Mr. Lynn Becker, Director, Energy and Minerals Department at 435-725-4972.

Curtis Cesspooch
Chairman, Tribal Business Committee

Cc: Dinah Peltier-BIA

William Stringer-BLM

Kelly Donohoue-Newfield

RECEIVED

OCT 04 2007

DIV. OF OIL, GAS & MINING

UNITED STATES
DEPARTMENT OF THE INTERIOR
BUREAU OF LAND MANAGEMENT

APPLICATION FOR PERMIT TO DRILL OR REENTER

5. Lease Serial No. 2OG0005609	
6. If Indian, Allottee or Tribe Name Ute	
7. If Unit or CA Agreement, Name and No. N/A	
8. Lease Name and Well No. Ute Tribal 4-8-5-2E	
9. API Well No. 43-647-39716	
10. Field and Pool, or Exploratory Undesignated	
11. Sec., T., R., M., or Blk. and Survey or Area SW/NW Sec. 8, T5S R2E	
12. County or Parish Uintah	13. State UT
14. Distance in miles and direction from nearest town or post office* Approximatley 26.2 miles southeast of Myton, Utah	
15. Distance from proposed* location to nearest property or lease line, ft. (Also to nearest drig. unit line, if any) Approx. 660' flse, NA/unit	
16. No. of Acres in lease NA	
17. Spacing Unit dedicated to this well 40 Acres	
18. Distance from proposed location* to nearest well, drilling, completed, applied for, on this lease, ft. NA	
19. Proposed Depth 6090'	
20. BLM/BIA Bond No. on file B002792	
21. Elevations (Show whether DF, KDB, RT, GL, etc) 4856' GL	
22. Approximate date work will start* 1st Quarter 2008	
23. Estimated duration Approximately seven (7) days from apud to rig release.	

Handwritten notes:
10/12/07
10/12/07

24. Attachments

The following, completed in accordance with the requirements of Onshore Oil and Gas Order No. 1, shall be attached to this form:

- Well plat certified by a registered surveyor.
- A Drilling Plan.
- A Surface Use Plan (if the location is on National Forest System Lands, the SUPO shall be filed with the appropriate Forest Service Office).
- Bond to cover the operations unless covered by an existing bond on file (see Item 20 above).
- Operator certification.
- Such other site specific information and/or plans as may be required by the authorized officer.

25. Signature <i>Mandie Crozier</i>	Name (Printed/Typed) Mandie Crozier	Date 10/12/07
Title Regulatory Specialist		
Approved by (Signature)	Name (Printed/Typed)	Date
Title	Office	


Application approval does not warrant or certify the the applicant holds legal or equitable title to those rights in the subject lease which would entitle the applicant to conduct operations thereon.
Conditions of approval, if any, are attached.

Title 18 U.S.C. Section 1001 and Title 43 U.S.C. Section 1212, make it a crime for any person knowingly and willfully to make to any department or agency of the United States any false, fictitious or fraudulent statements or representations as to any matter within its jurisdiction.

*(Instructions on reverse)

Surf
602411X
4435539Y
40.06578
-109.79914


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4435941Y
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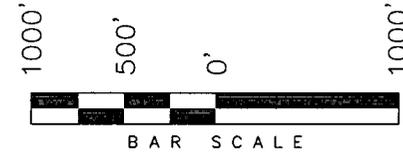
T5S, R2E, U.S.B.&M.

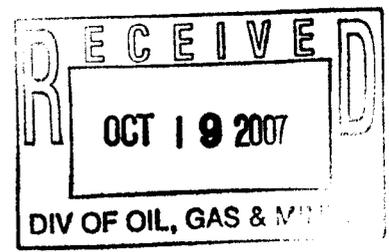NEWFIELD PRODUCTION COMPANY

WELL LOCATION, UTE TRIBAL 4-8-5-2,
 LOCATED AS SHOWN IN THE SW 1/4 NW
 1/4 OF SECTION 8, T5S, R2E, U.S.B.&M.
 UNITAH COUNTY, UTAH.




WELL LOCATION:
UTE TRIBAL 4-8-5-2
 ELEV. UNGRADED GROUND = 4855.6'

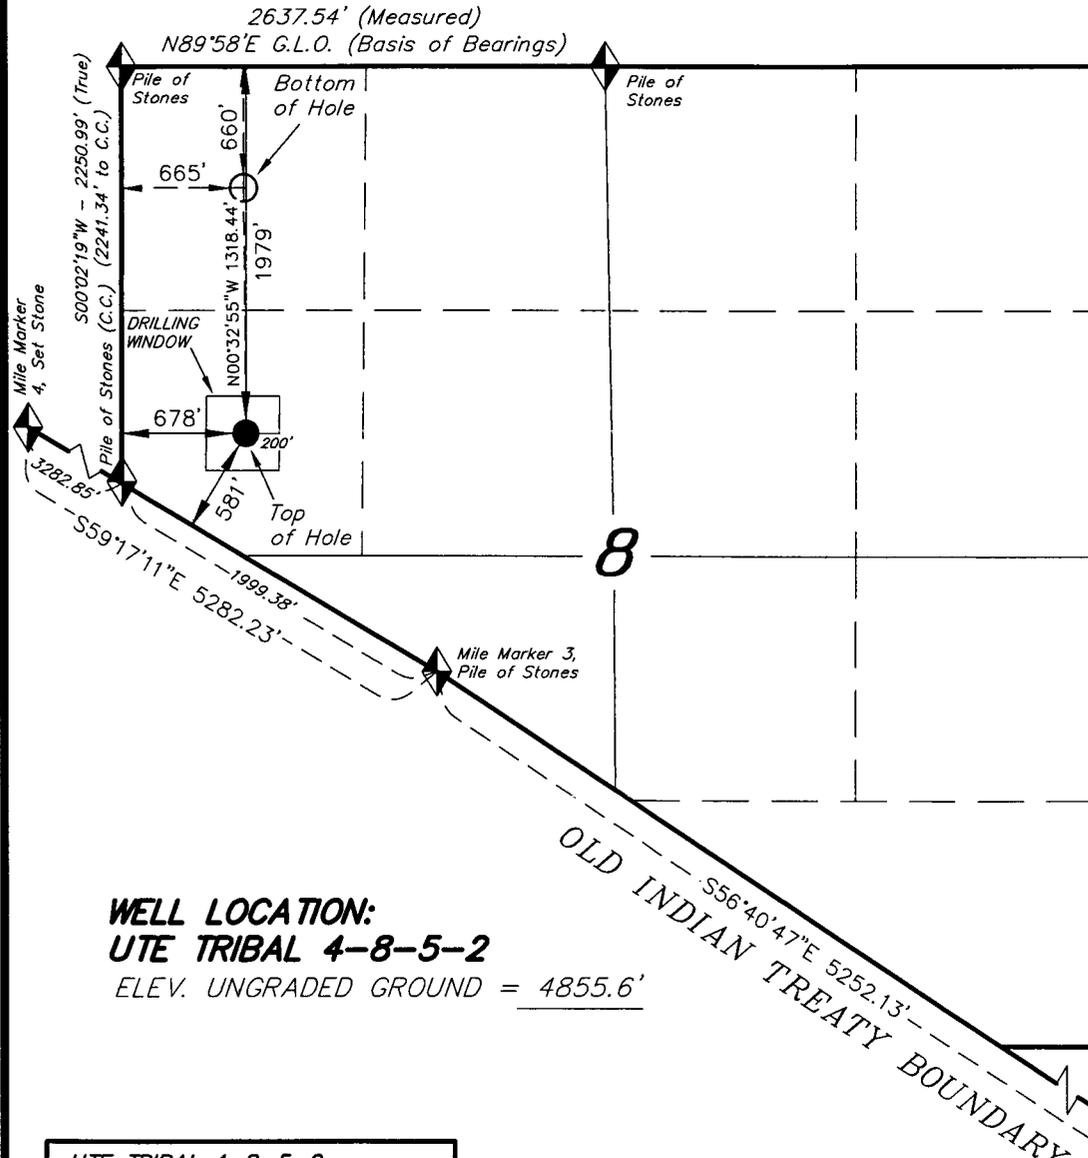

Note:
 Lots were not labeled on the G.L.O.
 Plat, so we have not shown them.

THIS IS TO CERTIFY THAT THE ABOVE PLAT WAS
 PREPARED FROM FIELD NOTES OF ACTUAL SURVEYS
 MADE BY ME OR UNDER MY SUPERVISION AND THAT
 THE SAME ARE TRUE AND CORRECT TO THE BEST OF
 MY KNOWLEDGE AND BELIEF. No. 189377

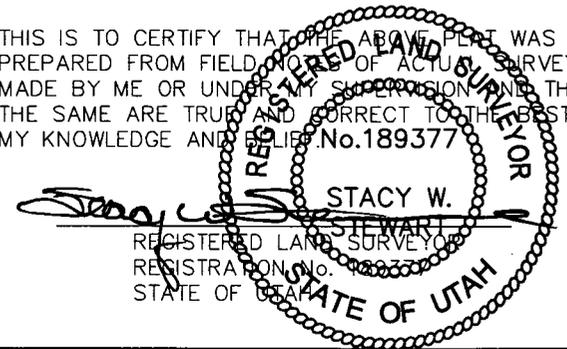

STACY W. STEWART
 REGISTERED LAND SURVEYOR
 REGISTRATION No. 189377
 STATE OF UTAH

UTE TRIBAL 4-8-5-2
 (Surface Location) NAD 83
 LATITUDE = 40° 03' 57.02"
 LONGITUDE = 109° 47' 59.43"

◆ = SECTION CORNERS LOCATED
 BASIS OF ELEV;
 U.S.G.S. 7-1/2 min QUAD (UTELAND BUTTE)

TRI STATE LAND SURVEYING & CONSULTING 180 NORTH VERNAL AVE. - VERNAL, UTAH 84078 (435) 781-2501	
DATE SURVEYED: 08-29-07	SURVEYED BY: C.M.
DATE DRAWN: 08-30-07	DRAWN BY: F.T.M.
REVISED:	SCALE: 1" = 1000'

**WORKSHEET
APPLICATION FOR PERMIT TO DRILL**

APD RECEIVED: 10/19/2007

API NO. ASSIGNED: 43-047-39716

WELL NAME: UTE TRIBAL 4-8-5-2E
 OPERATOR: NEWFIELD PRODUCTION (N2695)
 CONTACT: MANDIE CROZIER

PHONE NUMBER: 435-646-3721

PROPOSED LOCATION:

SWNW 08 050S 020E
 SURFACE: 2146 FNL 0700 FWL
 BOTTOM: 0660 FNL 0664 FWL
 COUNTY: UINTAH
 LATITUDE: 40.06532 LONGITUDE: -109.7991
 UTM SURF EASTINGS: 602417 NORTHINGS: 4435488
 FIELD NAME: UNDESIGNATED (2)

INSPECT LOCATN BY: / /		
Tech Review	Initials	Date
Engineering		
Geology		
Surface		

LEASE TYPE: 2 - Indian
 LEASE NUMBER: 20G0005609
 SURFACE OWNER: 2 - Indian

PROPOSED FORMATION: GRRV
 COALBED METHANE WELL? NO

RECEIVED AND/OR REVIEWED:


- Plat
- Bond: Fed[] Ind[2] Sta[] Fee[]
(No. B002792)
- Potash (Y/N)
- Oil Shale 190-5 (B) or 190-3 or 190-13
- Water Permit
(No. 43-10136)
- RDCC Review (Y/N)
(Date: _____)
- Fee Surf Agreement (Y/N)
- Intent to Commingle (Y/N)

LOCATION AND SITING:

- R649-2-3.
- Unit: _____
- R649-3-2. General
Siting: 460 From Qtr/Qtr & 920' Between Wells
- R649-3-3. Exception
- Drilling Unit
Board Cause No: _____
Eff Date: _____
Siting: _____
- R649-3-11. Directional Drill

COMMENTS: _____

STIPULATIONS: 1. Lease Approval
2. Sealing Strip

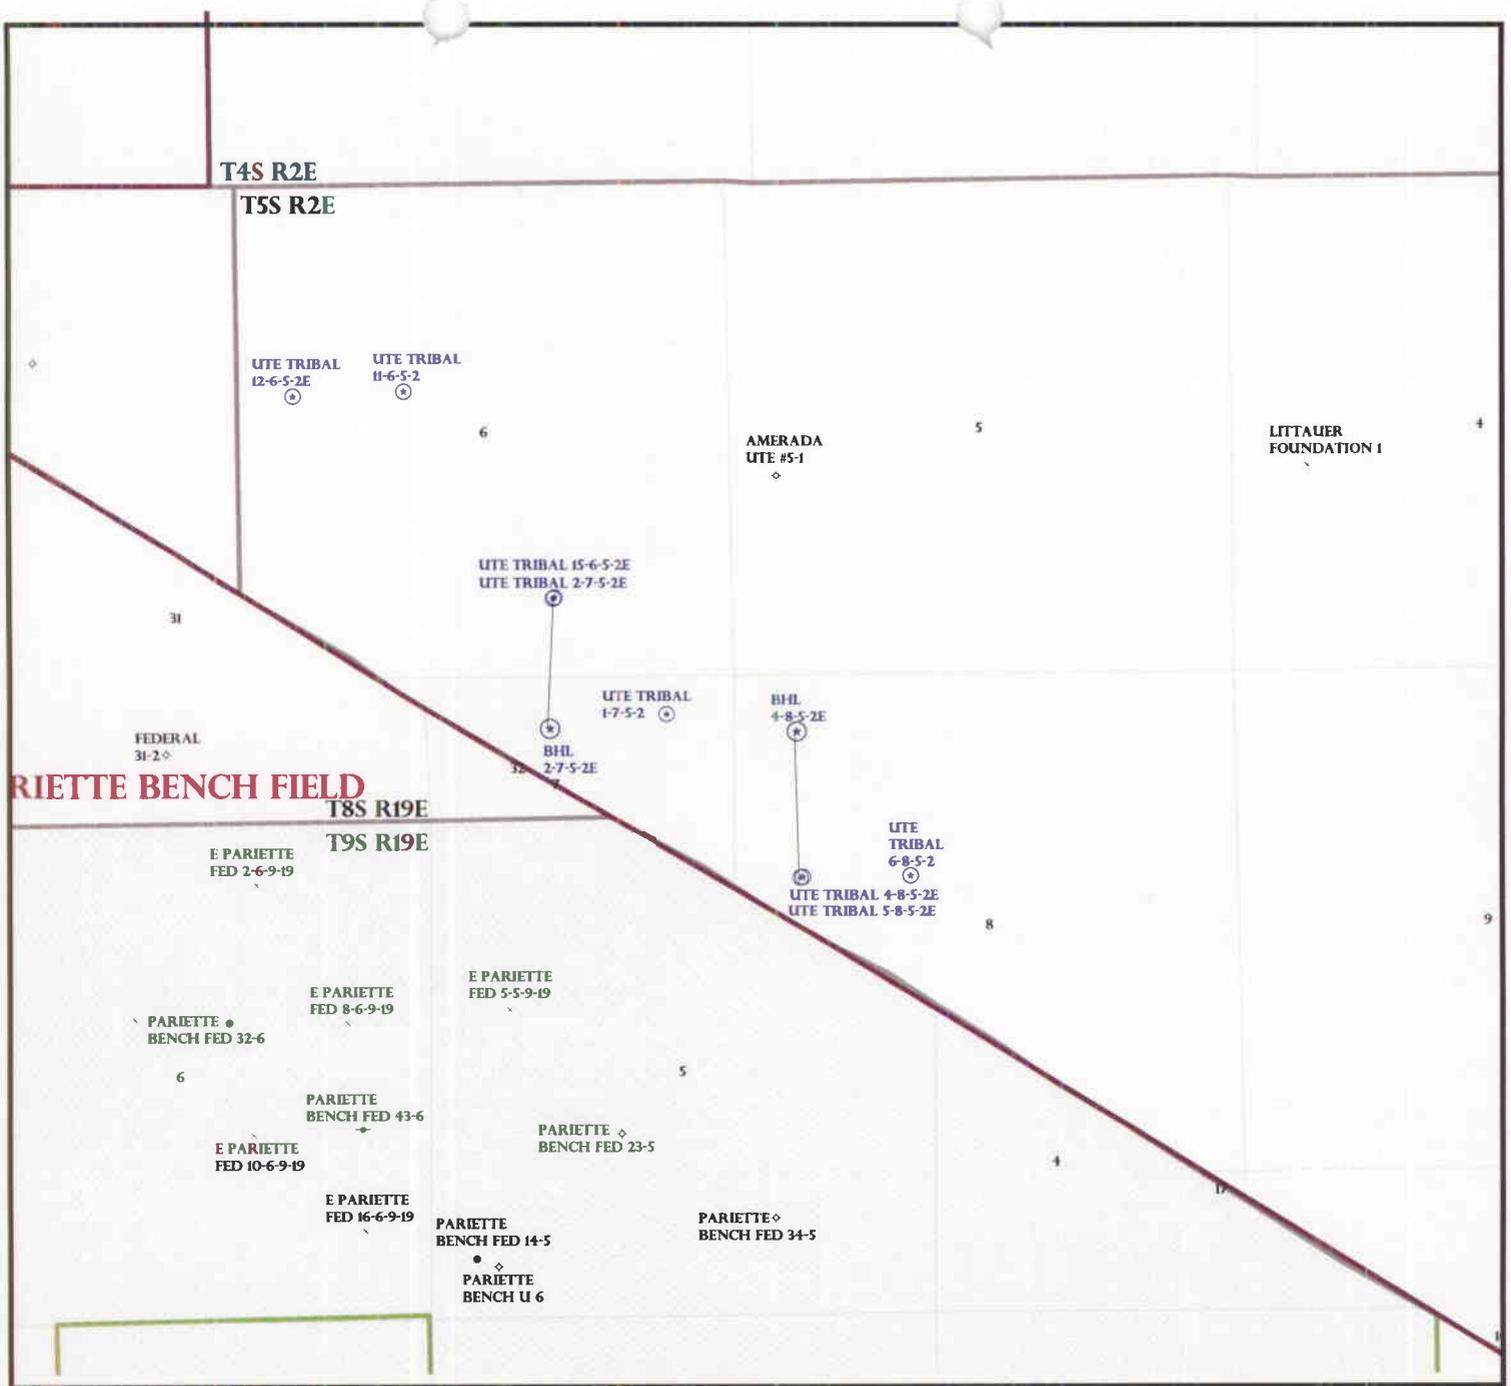

RIETTE BENCH FIELD

OPERATOR: NEWFIELD PROD CO (N2695)
 SEC: 6,8 T.5S R. 2E
 FIELD: UNDESIGNATED (002)
 COUNTY: DUCHESNE
 SPACING: R649-3-11 / DIRECTIONAL DRILLING

Field Status	Unit Status
ABANDONED	EXPLORATORY
ACTIVE	GAS STORAGE
COMBINED	NF PP OIL
INACTIVE	NF SECONDARY
PROPOSED	PENDING
STORAGE	PI OIL
TERMINATED	PP GAS
	PP GEOTHERML
	PP OIL
	SECONDARY
	TERMINATED

Wells Status

	GAS INJECTION
	GAS STORAGE
	LOCATION ABANDONED
	NEW LOCATION
	PLUGGED & ABANDONED
	PRODUCING GAS
	PRODUCING OIL
	SHUT-IN GAS
	SHUT-IN OIL
	TEMP. ABANDONED
	TEST WELL
	WATER INJECTION
	WATER SUPPLY
	WATER DISPOSAL
	DRILLING



PREPARED BY: DIANA MASON
 DATE: 25-OCTOBER-2007

UNITED STATES
DEPARTMENT OF THE INTERIOR
BUREAU OF LAND MANAGEMENT

APPLICATION FOR PERMIT TO DRILL OR REENTER

FORM APPROVED
OMB No. 1004-0136
Expires January 31, 2004

1a. Type of Work: <input checked="" type="checkbox"/> DRILL <input type="checkbox"/> REENTER		5. Lease Serial No. 20G0005609
1b. Type of Well: <input checked="" type="checkbox"/> Oil Well <input type="checkbox"/> Gas Well <input type="checkbox"/> Other <input checked="" type="checkbox"/> Single Zone <input type="checkbox"/> Multiple Zone		6. If Indian, Allottee or Tribe Name Ute
2. Name of Operator Newfield Production Company		7. If Unit or CA Agreement, Name and No. N/A
3a. Address Route #3 Box 3630, Myton UT 84052	3b. Phone No. (include area code) (435) 646-3721	8. Lease Name and Well No. Ute Tribal 4-8-5-2E
4. Location of Well (Report location clearly and in accordance with any State requirements. *) At surface SW/NW 2146' FNL 700' FWL At proposed prod. zone NW/NW 660' FNL 664' FWL		9. API Well No. 43-047-39714
14. Distance in miles and direction from nearest town or post office* Approximatley 26.2 miles southeast of Myton, Utah		10. Field and Pool, or Exploratory Undesignated
15. Distance from proposed* location to nearest property or lease line, ft. (Also to nearest drig. unit line, if any) Approx. 660' f/ise, NA' f/unit	16. No. of Acres in lease NA	11. Sec., T., R., M., or Blk. and Survey or Area SW/NW Sec. 8, T5S R2E
17. Spacing Unit dedicated to this well 40 Acres	18. Distance from proposed location* to nearest well, drilling, completed, applied for, on this lease, ft. NA	12. County or Parish Uintah
19. Proposed Depth 6090'	20. BLM/BIA Bond No. on file B002792	13. State UT
21. Elevations (Show whether DF, KDB, RT, GL, etc.) 4856' GL	22. Approximate date work will start* 1st Quarter 2008	23. Estimated duration Approximately seven (7) days from spud to rig release.

24. Attachments

The following, completed in accordance with the requirements of Onshore Oil and Gas Order No.1, shall be attached to this form:

- | | |
|---|--|
| 1. Well plat certified by a registered surveyor. | 4. Bond to cover the operations unless covered by an existing bond on file (see Item 20 above). |
| 2. A Drilling Plan. | 5. Operator certification. |
| 3. A Surface Use Plan (if the location is on National Forest System Lands, the SUPO shall be filed with the appropriate Forest Service Office). | 6. Such other site specific information and/or plans as may be required by the authorized officer. |

25. Signature 	Name (Printed/Typed) Mandie Crozier	Date 10/12/07
Title Regulatory Specialist		
Approved by (Signature) 	Name (Printed/Typed) BRADLEY G. HILL	Date 10-26-07
Title Office	ENVIRONMENTAL MANAGER	

Application approval does not warrant or certify the the applicant holds legal or equitable title to those rights in the subject lease which would entitle the applicant to conduct operations thereon.
Conditions of approval, if any, are attached.

Title 18 U.S.C. Section 1001 and Title 43 U.S.C. Section 1212, make it a crime for any person knowingly and willfully to make to any department or agency of the United States any false, fictitious or fraudulent statements or representations as to any matter within its jurisdiction.

*(Instructions on reverse)

Surf

602417X
44354884
40.06532
-109.79907

DHL

Federal Approval of this
Action is Necessary



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RECEIVED
OCT 24 2007
DIV. OF OIL, GAS & MINING

T5S, R2E, U.S.B.&M.

NEWFIELD PRODUCTION COMPANY


WELL LOCATION, UTE TRIBAL 4-8-5-2,
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 UNITAH COUNTY, UTAH.

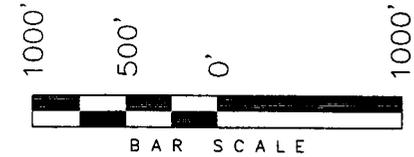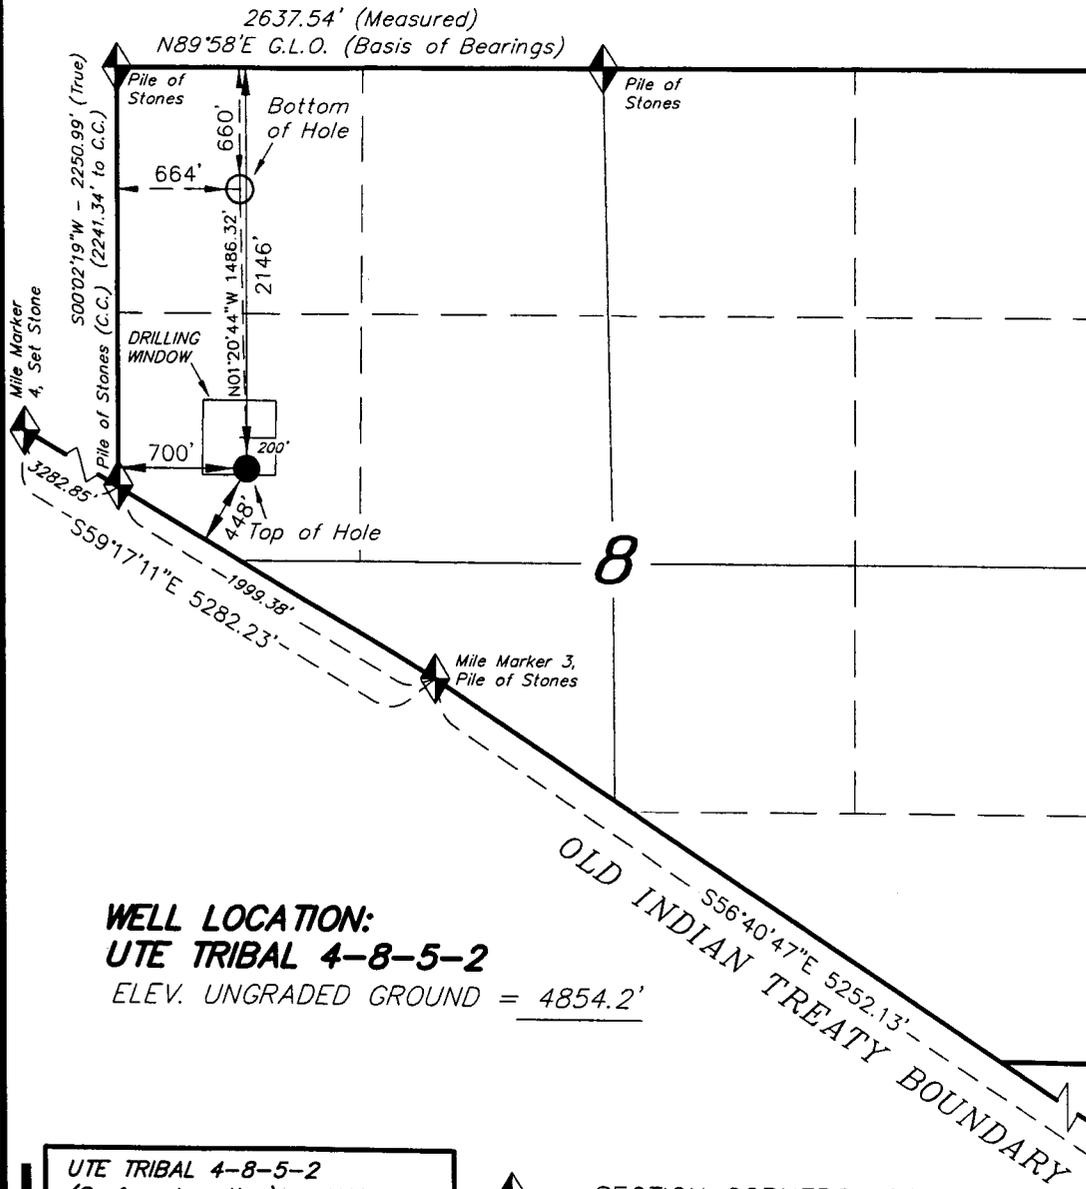

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 Plat, so we have not shown them.

WELL LOCATION:
UTE TRIBAL 4-8-5-2
 ELEV. UNGRADED GROUND = 4854.2'

THIS IS TO CERTIFY THAT THE ABOVE PLAT WAS
 PREPARED FROM FIELD NOTES OF ACTUAL SURVEYS
 MADE BY ME OR UNDER MY SUPERVISION AND THAT
 THE SAME ARE TRUE AND CORRECT TO THE BEST OF
 MY KNOWLEDGE AND BELIEF. No. 189377

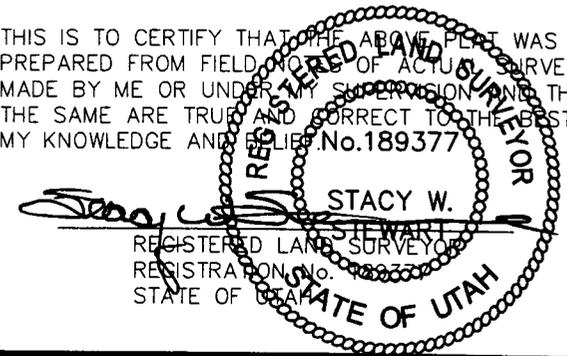

STACY W. STEWART
 REGISTERED LAND SURVEYOR
 REGISTRATION No. 189377
 STATE OF UTAH

UTE TRIBAL 4-8-5-2
(Surface Location) NAD 83
 LATITUDE = 40° 03' 55.37"
 LONGITUDE = 109° 47' 59.16"

◆ = SECTION CORNERS LOCATED

BASIS OF ELEV;
 U.S.G.S. 7-1/2 min QUAD (UTELAND BUTTE)

TRI STATE LAND SURVEYING & CONSULTING

180 NORTH VERNAL AVE. - VERNAL, UTAH 84078
 (435) 781-2501

DATE SURVEYED: 09-06-07	SURVEYED BY: C.M.
DATE DRAWN: 09-07-07	DRAWN BY: F.T.M.
REVISED:	SCALE: 1" = 1000'



JON M. HUNTSMAN, JR.
Governor

GARY R. HERBERT
Lieutenant Governor

State of Utah

DEPARTMENT OF NATURAL RESOURCES

MICHAEL R. STYLER
Executive Director

Division of Oil Gas and Mining

JOHN R. BAZA
Division Director

October 26, 2007

Newfield Production Company
Rt. #3, Box 3630
Myton, UT 84052

Re: Ute Tribal 4-8-5-2E Well, Surface Location 2146' FNL, 700' FWL, SW NW, Sec. 8,
T. 5 South, R. 2 East, Bottom Location 660' FNL, 664' FWL, NW NW, Sec. 8,
T. 5 South, R. 2 East, Uintah County, Utah

Gentlemen:

Pursuant to the provisions and requirements of Utah Code Ann. § 40-6-1 *et seq.*, Utah Administrative Code R649-3-1 *et seq.*, and the attached Conditions of Approval, approval to drill the referenced well is granted.

This approval shall expire one year from the above date unless substantial and continuous operation is underway, or a request for extension is made prior to the expiration date. The API identification number assigned to this well is 43-047-39716.

Sincerely,

Gil Hunt
Associate Director

pab
Enclosures

cc: Uintah County Assessor
Bureau of Land Management, Vernal Office

Operator: Newfield Production Company
Well Name & Number Ute Tribal 4-8-5-2E
API Number: 43-047-39716
Lease: 2OG0005609

Surface Location: SW NW **Sec. 8** **T. 5 South** **R. 2 East**
Bottom Location: NW NW **Sec. 8** **T. 5 South** **R. 2 East**

Conditions of Approval

1. General

Compliance with the requirements of Utah Admin. R. 649-1 *et seq.*, the Oil and Gas Conservation General Rules, and the applicable terms and provisions of the approved Application for permit to drill.

2. Notification Requirements

Notify the Division within 24 hours of spudding the well.

- Contact Carol Daniels at (801) 538-5284

Notify the Division prior to commencing operations to plug and abandon the well.

- Contact Dustin Doucet at (801) 538-5281 (801) 733-0983 home

3. Reporting Requirements

All required reports, forms and submittals will be promptly filed with the Division, including but not limited to the Entity Action Form (Form 6), Report of Water Encountered During Drilling (Form 7), Weekly Progress Reports for drilling and completion operations, and Sundry Notices and Reports on Wells requesting approval of change of plans or other operational actions.

4. State approval of this well does not supersede the required federal approval, which must be obtained prior to drilling.
5. In accordance with Utah Admin. R.649-3-11, Directional Drilling, the operator shall submit a complete angular deviation and directional survey report to the Division within 30 days following completion of the well.
6. This proposed well is located in an area for which drilling units (well spacing patterns) have not been established through an order of the Board of Oil, Gas and Mining (the "Board"). In order to avoid the possibility of waste or injury to correlative rights, the operator is requested, once the well has been drilled, completed, and has produced, to analyze geological and engineering data generated therefrom, as well as any similar data from surrounding areas if available. As soon as is practicable after completion of its analysis, and if the analysis suggests an area larger than the quarter-quarter section upon which the well is located is being drained, the operator is requested to seek an appropriate order from the Board establishing drilling and spacing units in conformance with such analysis by filing a Request for Agency Action with the Board.

RECEIVED
 VERNAL FIELD OFFICE
 2007 OCT 23 PM 1:41

Form 3160-3
 (September 2001)

UNITED STATES
 DEPARTMENT OF THE INTERIOR
 BUREAU OF LAND MANAGEMENT

DEPT. OF THE INTERIOR
 BUREAU OF LAND MGMT.

FORM APPROVED
 OMB No. 1004-0136
 Expires January 31, 2004

APPLICATION FOR PERMIT TO DRILL OR REENTER

5. Lease Serial No.	2OG0005609
6. If Indian, Allottee or Tribe Name	Ute
7. If Unit or CA Agreement, Name and No.	N/A
8. Lease Name and Well No.	Ute Tribal 4-8-5-2E
9. API Well No.	43-047-397116
10. Field and Pool, or Exploratory	Undesignated
11. Sec., T., R., M., or Blk. and Survey or Area	SW/NW Sec. 8, T5S R2E
12. County or Parish	Uintah
13. State	UT

1a. Type of Work: <input checked="" type="checkbox"/> DRILL <input type="checkbox"/> REENTER		
1b. Type of Well: <input checked="" type="checkbox"/> Oil Well <input type="checkbox"/> Gas Well <input type="checkbox"/> Other <input checked="" type="checkbox"/> Single Zone <input type="checkbox"/> Multiple Zone		
2. Name of Operator Newfield Production Company		9. API Well No. 43-047-397116
3a. Address Route #3 Box 3630, Myton UT 84052	3b. Phone No. (include area code) (435) 646-3721	10. Field and Pool, or Exploratory Undesignated
4. Location of Well (Report location clearly and in accordance with any State requirements. *) At surface SW/NW 2146' FNL 700' FWL At proposed prod. zone NW/NW 660' FNL 664' FWL		11. Sec., T., R., M., or Blk. and Survey or Area SW/NW Sec. 8, T5S R2E
14. Distance in miles and direction from nearest town or post office* Approximatley 26.2 miles southeast of Myton, Utah		12. County or Parish Uintah
15. Distance from proposed* location to nearest property or lease line, ft. (Also to nearest drig. unit line, if any) Approx. 660' f/lse, NA' f/unit NA		13. State UT
16. No. of Acres in lease NA	17. Spacing Unit dedicated to this well 40 Acres	
18. Distance from proposed location* to nearest well, drilling, completed, applied for, on this lease, ft. NA	19. Proposed Depth 6090'	20. BLM/BIA Bond No. on file B002792
21. Elevations (Show whether DF, KDB, RT, GL, etc.) 4856' GL	22. Approximate date work will start* 1st Quarter 2008	23. Estimated duration Approximately seven (7) days from spud to rig release.

24. Attachments

The following, completed in accordance with the requirements of Onshore Oil and Gas Order No.1, shall be attached to this form:

- Well plat certified by a registered surveyor.
- A Drilling Plan.
- A Surface Use Plan (if the location is on National Forest System Lands, the SUPO shall be filed with the appropriate Forest Service Office).
- Bond to cover the operations unless covered by an existing bond on file (see Item 20 above).
- Operator certification.
- Such other site specific information and/or plans as may be required by the authorized officer.

25. Signature 	Name (Printed/Typed) Mandie Crozier	Date 10/12/07
Title Regulatory Specialist		
Approved by (Signature) 	Name (Printed/Typed) Jerry Kucicka	Date 1-17-2008
Title Assistant Field Manager Lands & Mineral Resources	Office VERNAL FIELD OFFICE	

Application approval does not warrant or certify the the applicant holds legal or equitable title to those rights in the subject lease which would entitle the applicant to conduct operations thereon.
 Conditions of approval, if any, are attached.

Title 18 U.S.C. Section 1001 and Title 43 U.S.C. Section 1212, make it a crime for any person knowingly and willfully to make to any department or agency of the United States any false, fictitious or fraudulent statements or representations as to any matter within its jurisdiction.

*(Instructions on reverse)

RECEIVED

JAN 23 2008

DIV. OF OIL, GAS & MINING

NOTICE OF APPROVAL

CONDITIONS OF APPROVAL ATTACHED



**UNITED STATES DEPARTMENT OF THE INTERIOR
BUREAU OF LAND MANAGEMENT
VERNAL FIELD OFFICE**

170 South 500 East

VERNAL, UT 84078

(435) 781-4400



CONDITIONS OF APPROVAL FOR APPLICATION FOR PERMIT TO DRILL

Company: Newfield Production Company
Well No: Ute Tribal 4-8-5-2E
API No: 43-047- 39716

Location: SWNW, Sec. 8, T5S, R2E
Lease No: 2OG0005609
Agreement: N/A

Title	Name	Office Phone Number	Cell Phone Number
Petroleum Engineer:	Matt Baker	(435) 781-4490	(435) 828-4470
Petroleum Engineer:	Michael Lee	(435) 781-4432	(435) 828-7875
Petroleum Engineer:	James Ashley	(435) 781-4470	(435) 828-7874
Petroleum Engineer:	Ryan Angus	(435) 781-4430	(435) 828-7368
Supervisory Petroleum Technician:	Jamie Sparger	(435) 781-4502	(435) 828-3913
NRS/Enviro Scientist:	Paul Buhler	(435) 781-4475	(435) 828-4029
NRS/Enviro Scientist:	Karl Wright	(435) 781-4484	(435) 828-7381
NRS/Enviro Scientist:	Holly Villa	(435) 781-4404	
NRS/Enviro Scientist:		(435) 781-4476	
NRS/Enviro Scientist:	Chuck Macdonald	(435) 781-4441	(435) 828-7481
NRS/Enviro Scientist:	Jannice Cutler	(435) 781-3400	(435) 828-3544
NRS/Enviro Scientist:	Michael Cutler	(435) 781-3401	(435) 828-3546
NRS/Enviro Scientist:	Anna Figueroa	(435) 781-3407	(435) 828-3548
NRS/Enviro Scientist:	Verlyn Pindell	(435) 781-3402	(435) 828-3547
NRS/Enviro Scientist:	Darren Williams	(435) 781-4447	
NRS/Enviro Scientist:	Nathan Packer	(435) 781-3405	(435) 828-3545

Fax: (435) 781-3420

**A COPY OF THESE CONDITIONS SHALL BE FURNISHED TO YOUR
FIELD REPRESENTATIVE TO INSURE COMPLIANCE**

All lease and/or unit operations are to be conducted in such a manner that full compliance is made with the applicable laws, regulations (43 CFR Part 3160), and this approved Application for Permit to Drill including Surface and Downhole Conditions of Approval. The operator is considered fully responsible for the actions of his subcontractors. A copy of the approved APD must be on location during construction, drilling, and completion operations. **This permit is approved for a two (2) year period, or until lease expiration, whichever occurs first. An additional extension, up to two (2) years, may be applied for by sundry notice prior to expiration.**

NOTIFICATION REQUIREMENTS

Construction Activity	-	The Ute Tribe Energy & Minerals Dept. shall be notified in writing 48 hours in advance of any construction activity. The Ute Tribal office is open Monday through Thursday.
Construction Completion	-	Upon completion of the pertinent APD/ROW construction, notify the Ute Tribe Energy & Minerals Dept. for a Tribal Technician to verify the Affidavit of Completion.
Spud Notice (Notify Petroleum Engineer)	-	Twenty-Four (24) hours prior to spudding the well.
Casing String & Cementing (Notify Supv. Petroleum Tech.)	-	Twenty-Four (24) hours prior to running casing and cementing all casing strings.
BOP & Related Equipment Tests (Notify Supv. Petroleum Tech.)	-	Twenty-Four (24) hours prior to initiating pressure tests.
First Production Notice (Notify Petroleum Engineer)	-	Within Five (5) business days after new well begins or production resumes after well has been off production for more than ninety (90) days.

**SURFACE USE PROGRAM
CONDITIONS OF APPROVAL (COAs)**

General Conditions of Approval

- A 30 foot corridor right-of-way shall be approved. Upon completion of each pipeline in corridor, they shall be identified and filed with the Ute Tribe.
- A qualified Archaeologist accompanied by a Tribal Technician will monitor trenching construction of pipeline.
- The Ute Tribe Energy & Minerals Department is to be notified, in writing 48 hours prior to construction of pipeline.
- Construction Notice shall be given to the department on the Ute Tribe workdays, which are Monday through Thursday. The Company understands that they may be responsible for costs incurred by the Ute Tribe after hours.
- The Company shall inform contractors to maintain construction of pipelines within the approved ROW's.
- The Company shall assure the Ute Tribe that "ALL CONTRACTORS, INCLUDING SUB-CONTRACTORS, LEASING CONTRACTORS, AND ETC." have acquired a current and valid Ute Tribal Business License and have "Access Permits" prior to construction, and will have these permits in all vehicles at all times.
- You are hereby notified that working under the "umbrella" of a company does not allow you to be in the field, and can be subject to those fines of the Ute Tribe Severance Tax Ordinance.
- Any deviation of submitted APD's and ROW applications the Companies will notify the Ute Tribe and BIA in writing and will receive written authorization of any such change with appropriate authorization.
- The Company will implement "Safety and Emergency Plan." The Company's safety director will ensure its compliance.
- All Company employees and/or authorized personnel (sub-contractors) in the field will have approved applicable APD's and/or ROW permits/authorizations on their person(s) during all phases of construction.
- All vehicular traffic, personnel movement, construction/restoration operations should be confined to the area examined and approved, and to the existing roadways and/or evaluated access routes.
- All personnel should refrain from collecting artifacts, any paleontological fossils, and from disturbing any significant cultural resources in the area.
- The personnel from the Ute Tribe Energy & Minerals Department should be notified should cultural remains from subsurface deposits be exposed or identified during construction. All construction will cease.
- All mitigative stipulations contained in the Bureau of Indian Affairs Site Specific Environmental Assessment (EA) will be strictly adhered.
- Upon completion of Application for Corridor Right-Way, the company will notify the Ute Tribe Energy & Minerals Department, so that a Tribal Technician can verify Affidavit of Completion.

ADDITIONAL CONDITIONS OF APPROVAL:

- See additional stipulations on page 2.
- See BIM COA on page 3
- For any other additional stipulations, see concurrence letter.

DOWNHOLE PROGRAM
CONDITIONS OF APPROVAL (COAs)

SITE SPECIFIC DOWNHOLE COAs:

- A surface casing shoe integrity test shall be performed.
- Production casing cement top shall be a minimum of 200' above the surface casing shoe.

All provisions outlined in Onshore Oil & Gas Order #2 Drilling Operations shall be strictly adhered to. The following items are emphasized:

DRILLING/COMPLETION/PRODUCING OPERATING STANDARDS

- The spud date and time shall be reported orally to Vernal Field Office within 24 hours of spudding.
- Notify Vernal Field Office Supervisory Petroleum Engineering Technician at least 24 hours in advance of casing cementing operations and BOPE & casing pressure tests.
- Blowout prevention equipment (BOPE) shall remain in use until the well is completed or abandoned. Closing unit controls shall remain unobstructed and readily accessible at all times. Choke manifolds shall be located outside of the rig substructure.
- All BOPE components shall be inspected daily and those inspections shall be recorded in the daily drilling report. Components shall be operated and tested as required by Onshore Oil & Gas Order No. 2 to insure good mechanical working order. All BOPE pressure tests shall be performed by a test pump with a chart recorder and **NOT** by the rig pumps. Test shall be reported in the driller's log.
- BOP drills shall be initially conducted by each drilling crew within 24 hours of drilling out from under the surface casing and weekly thereafter as specified in Onshore Oil & Gas Order No. 2.
- Casing pressure tests are required before drilling out from under all casing strings set and cemented in place.
- No aggressive/fresh hard-banded drill pipe shall be used within casing.
- **Cement baskets shall not be run on surface casing.**
- The operator must report all shows of water or water-bearing sands to the BLM. If flowing water is encountered it must be sampled, analyzed, and a copy of the analyses submitted to the BLM Vernal Field Office.
- The operator must report encounters of all non oil & gas mineral resources (such as Gilsonite, tar sands, oil shale, trona, etc.) to the Vernal Field Office, in writing, within 5 working days of each encounter. Each report shall include the well name/number, well location, date and depth (from KB or GL) of encounter, vertical footage of the encounter and, the name of the person making the report (along with a telephone number) should the BLM need to obtain additional information.

- A complete set of angular deviation and directional surveys of a directional well will be submitted to the Vernal BLM office engineer within 30 days of the completion of the well.
- While actively drilling, chronologic drilling progress reports shall be filed directly with the BLM, Vernal Field Office on a weekly basis in sundry, letter format or e-mail to the Petroleum Engineers until the well is completed.
- A cement bond log (CBL) will be run from the production casing shoe to the top of cement and shall be utilized to determine the bond quality for the production casing. Submit a field copy of the CBL to this office.
- **Please submit an electronic copy of all other logs run on this well in LAS format to UT_VN_Welllogs@BLM.gov. This submission will supersede the requirement for submittal of paper logs to the BLM.**
- There shall be no deviation from the proposed drilling, completion, and/or workover program as approved. Safe drilling and operating practices must be observed. Any changes in operation must have prior approval from the BLM Vernal Field Office.

OPERATING REQUIREMENT REMINDERS:

- All wells, whether drilling, producing, suspended, or abandoned, shall be identified in accordance with 43 CFR 3162.6. There shall be a sign or marker with the name of the operator, lease serial number, well number, and surveyed description of the well.
- In accordance with 43 CFR 3162.4-3, this well shall be reported on the "Monthly Report of Operations" (Oil and Gas Operations Report ((OGOR)) starting with the month in which operations commence and continue each month until the well is physically plugged and abandoned. This report shall be filed in duplicate, directly with the Minerals Management Service, P.O. Box 17110, Denver, Colorado 80217-0110, or call 1-800-525-7922 (303) 231-3650 for reporting information.
- Should the well be successfully completed for production, the BLM Vernal Field office must be notified when it is placed in a producing status. Such notification will be by written communication and must be received in this office by not later than the fifth business day following the date on which the well is placed on production. The notification shall provide, as a minimum, the following informational items:
 - Operator name, address, and telephone number.
 - Well name and number.
 - Well location (¼¼, Sec., Twn, Rng, and P.M.).
 - Date well was placed in a producing status (date of first production for which royalty will be paid).
 - The nature of the well's production, (i.e., crude oil, or crude oil and casing head gas, or natural gas and entrained liquid hydrocarbons).
 - ^a The Federal or Indian lease prefix and number on which the well is located; otherwise the non-Federal or non-Indian land category, i.e., State or private.
 - Unit agreement and/or participating area name and number, if applicable.
 - Communitization agreement number, if applicable.
- Any venting or flaring of gas shall be done in accordance with Notice to Lessees (NTL) 4A and needs prior approval from the BLM Vernal Field Office.
- All undesirable events (fires, accidents, blowouts, spills, discharges) as specified in NTL 3A will be reported to the BLM, Vernal Field Office. Major events, as defined in NTL3A, shall be reported verbally within 24 hours, followed by a written report within 15 days. "Other than Major Events" will be reported in writing within 15 days. "Minor Events" will be reported on the Monthly Report of Operations and Production.
- Whether the well is completed as a dry hole or as a producer, "Well Completion and Recompletion Report and Log" (BLM Form 3160-4) shall be submitted not later than 30 days after completion of the well or after completion of operations being performed, in accordance with 43 CFR 3162.4-1. Two copies of all logs run, core descriptions, and all other surveys or

data obtained and compiled during the drilling, workover, and/or completion operations, shall be filed on BLM Form 3160-4. Submit with the well completion report a geologic report including, at a minimum, formation tops, and a summary and conclusions. Also include deviation surveys, sample descriptions, strip logs, core data, drill stem test data, and results of production tests if performed. Samples (cuttings, fluid, and/or gas) shall be submitted only when requested by the BLM, Vernal Field Office.

- All off-lease storage, off-lease measurement, or commingling on-lease or off-lease, shall have prior written approval from the BLM Vernal Field Office.
- Oil and gas meters shall be calibrated in place prior to any deliveries. The BLM Vernal Field Office Petroleum Engineers will be provided with a date and time for the initial meter calibration and all future meter proving schedules. A copy of the meter calibration reports shall be submitted to the BLM Vernal Field Office. All measurement facilities will conform to the API standards for liquid hydrocarbons and the AGA standards for natural gas measurement. All measurement points shall be identified as the point of sale or allocation for royalty purposes.
- A schematic facilities diagram as required by Onshore Oil & Gas Order No. 3 shall be submitted to the BLM Vernal Field Office within 30 days of installation or first production, whichever occurs first. All site security regulations as specified in Onshore Oil & Gas Order No. 3 shall be adhered to. All product lines entering and leaving hydrocarbon storage tanks will be effectively sealed in accordance with Onshore Oil & Gas Order No. 3.
- Any additional construction, reconstruction, or alterations of facilities, including roads, gathering lines, batteries, etc., which will result in the disturbance of new ground, shall require the filing of a suitable plan and need prior approval of the BLM Vernal Field Office. Emergency approval may be obtained orally, but such approval does not waive the written report requirement.
- No location shall be constructed or moved, no well shall be plugged, and no drilling or workover equipment shall be removed from a well to be placed in a suspended status without prior approval of the BLM Vernal Field Office. If operations are to be suspended for more than 30 days, prior approval of the BLM Vernal Field Office shall be obtained and notification given before resumption of operations.
- Pursuant to Onshore Oil & Gas Order No. 7, this is authorization for pit disposal of water produced from this well for a period of 90 days from the date of initial production. A permanent disposal method must be approved by this office and in operation prior to the end of this 90-day period. In order to meet this deadline, an application for the proposed permanent disposal method shall be submitted along with any necessary water analyses, as soon as possible, but no later than 45 days after the date of first production. Any method of disposal which has not been approved prior to the end of the authorized 90-day period will be considered as an Incident of Noncompliance and will be grounds for issuing a shut-in order until an acceptable manner for disposing of said water is provided and approved by this office.
- Unless the plugging is to take place immediately upon receipt of oral approval, the Field Office Petroleum Engineers must be notified at least 24 hours in advance of the plugging of the well, in order that a representative may witness plugging operations. If a well is suspended or abandoned, all pits must be fenced immediately until they are backfilled. The "Subsequent Report of Abandonment" (Form BLM 3160-5) must be submitted within 30 days after the actual plugging of the well bore, showing location of plugs, amount of cement in each, and amount of casing left in hole, and the current status of the surface restoration.

DIVISION OF OIL, GAS AND MINING

SPUDDING INFORMATION

Name of Company: NEWFIELD PRODUCTION COMPANY

Well Name: UTE TRIBAL 4-8-5-2E

Api No: 43-047-39716 Lease Type: INDIAN

Section 08 Township 05S Range 02E County UINTAH

Drilling Contractor ROSS DRILLING RIG # 21

SPUDDED:

Date 08/07/08

Time 11:10 AM

How DRY

Drilling will Commence: _____

Reported by SEAN STEVENS

Telephone # (435) 823-1162

Date 08/07/08 Signed CHD

UNITED STATES
DEPARTMENT OF THE INTERIOR
BUREAU OF LAND MANAGEMENT

SUNDRY NOTICES AND REPORTS ON WELLS
Do not use this form for proposals to drill or to re-enter an abandoned well. Use Form 3160-3 (APD) for such proposals.

5. Lease Serial No.
2060005609

6. If Indian, Allottee or Tribe Name.

7. If Unit or CA/Agreement, Name and/or

8. Well Name and No.
UTE TRIBAL 4-8-5-2E

9. API Well No.
4304739716

10. Field and Pool, or Exploratory Area
MONUMENT BUTTE

11. County or Parish, State
UINTAH, UT

SUBMIT IN TRIPLICATE - Other Instructions on page 2

1. Type of Well
 Oil Well Gas Well Other

2. Name of Operator
NEWFIELD PRODUCTION COMPANY

3a. Address Route 3 Box 3630
Myton, UT 84052

3b. Phone (include are code)
435.646.3721

4. Location of Well (Footage, Sec., T., R., M., or Survey Description)
2146 FNL 700 FWL
NWNW Section 8 T5S R2E

12. CHECK APPROPRIATE BOX(ES) TO INDICATE NATURE OF NOTICE, OR OTHER DATA

TYPE OF SUBMISSION	TYPE OF ACTION			
<input type="checkbox"/> Notice of Intent	<input type="checkbox"/> Acidize	<input type="checkbox"/> Deepen	<input type="checkbox"/> Production (Start/Resume)	<input type="checkbox"/> Water Shut-Off
<input checked="" type="checkbox"/> Subsequent Report	<input type="checkbox"/> Alter Casing	<input type="checkbox"/> Fracture Treat	<input type="checkbox"/> Reclamation	<input type="checkbox"/> Well Integrity
<input type="checkbox"/> Final Abandonment	<input type="checkbox"/> Casing Repair	<input type="checkbox"/> New Construction	<input type="checkbox"/> Recomplete	<input checked="" type="checkbox"/> Other _____
	<input type="checkbox"/> Change Plans	<input type="checkbox"/> Plug & Abandon	<input type="checkbox"/> Temporarily Abandon	Spud Notice _____
	<input type="checkbox"/> Convert to Injector	<input type="checkbox"/> Plug Back	<input type="checkbox"/> Water Disposal	_____

13. Describe Proposed or Completed Operation: (Clearly state all pertinent details, including estimated starting date of any proposed work and approximate duration thereof. If the proposal is to deepen directionally or recomplete horizontally, give subsurface locations and measured and true vertical depths of all pertinent markers and zones. Attach the Bond under which the work will be performed or provide the Bond No. on file with BLM/BIA. Required subsequent reports shall be filed within 30 days following completion of the involved operations. If the operation results in a multiple completion or recompletion in a new interval, a Form 3160-4 shall be filed once testing has been completed. Final Abandonment Notices shall be filed only after all requirements, including reclamation, have been completed, and the operator has determined that the site is ready for final inspection.)

On 8/7/08 MIRU Ross # 21. Spud well @ 11:10 AM. Drill 330' of 12 1/4" hole with air mist. TIH W/ 7 Jt's 8 5/8" J-55 24 # csgn. Set @ 325.46 KB. On 8/8/08 cement with 160 sks of class "G" w/ 3% CaCL2 + 1/4# sk Cello- Flake Mixed @ 15.8 ppg > 1.17 cf/sk yeild. Returned 2 bbls cement to pit. WOC.

I hereby certify that the foregoing is true and correct (Printed/ Typed) Ryan Crum	Title Drilling Foreman
Signature 	Date 08/08/2008

THIS SPACE FOR FEDERAL OR STATE OFFICE USE

Approved by	Title	Date
Conditions of approval, if any, are attached. Approval of this notice does not warrant or certify that the applicant holds legal or equitable title to those rights in the subject lease which would entitle the applicant to conduct operations thereon.	Office	

Title 18 U.S.C. Section 1001 and Title 43 U.S.C. Section 1212, make it a crime for any person knowingly and willfully to make to any department or agency of the United States any false, fictitious and fraudulent statements or representations as to any matter within its jurisdiction

(Instructions on page 2)

RECEIVED

AUG 13 2008

NEWFIELD PRODUCTION COMPANY - CASING & CEMENT REPORT

8 5/8 CASING SET AT 325.46

LAST CASING 8 5/8" SET AT 325.46
 DATUM 12' KB
 DATUM TO CUT OFF CASING _____
 DATUM TO BRADENHEAD FLANGE _____
 TD DRILLER 330' LOGGER _____
 HOLE SIZE 12 1/4

OPERATOR Newfield Production Company
 WELL Ute Tribal 4-8-5-2E
 FIELD/PROSPECT Monument Butte
 CONTRACTOR & RIG # Ross # 21

LOG OF CASING STRING:							
PIECES	OD	ITEM - MAKE - DESCRIPTION	WT / FT	GRD	THREAD	CONDT	LENGTH
		Shoe Joint 44.80'					
		WHI - 92 csg head			8rd	A	0.95
7	8 5/8"	Maverick ST&C csg	24#	J-55	8rd	A	313.61
		GUIDE shoe			8rd	A	0.9
CASING INVENTORY BAL.		FEET	JTS	TOTAL LENGTH OF STRING			315.46
TOTAL LENGTH OF STRING		315.46	7	LESS CUT OFF PIECE			2
LESS NON CSG. ITEMS		1.85		PLUS DATUM TO T/CUT OFF CSG			12
PLUS FULL JTS. LEFT OUT		0		CASING SET DEPTH			325.46
TOTAL		313.61	7	} COMPARE			
TOTAL CSG. DEL. (W/O THRDS)		313.61	7				
TIMING		1ST STAGE					
BEGIN RUN CSG.	Spud	11:10AM	8/7/2008	GOOD CIRC THRU JOB <u>Yes</u>			
CSG. IN HOLE			8/7/2008	Bbls CMT CIRC TO SURFACE <u>2</u>			
BEGIN CIRC		7:45 AM	8/8/2008	RECIPROCATED PIPE FOR _____ THRU _____ FT STROKE			
BEGIN PUMP CMT		8:58AM	8/8/2008	N/A			
BEGIN DSPL. CMT		9:11 AM	8/8/2008	BUMPED PLUG TO <u>137</u> PSI			
PLUG DOWN		9:18 AM	8/8/2008				
CEMENT USED		CEMENT COMPANY- B. J.					
STAGE	# SX	CEMENT TYPE & ADDITIVES					
1	160	Class "G" w/ 2% CaCL2 + 1/4#/sk Cello-Flake mixed @ 15.8 ppg 1.17 cf/sk yield					
CENTRALIZER & SCRATCHER PLACEMENT		SHOW MAKE & SPACING					
Centralizers - Middle first, top second & third for 3							

COMPANY REPRESENTATIVE Ryan Crum DATE 8/8/2008

UNITED STATES
DEPARTMENT OF THE INTERIOR
BUREAU OF LAND MANAGEMENT

FORM APPROVED
OMB No. 1004-0137
Expires: July 31, 2010

SUNDRY NOTICES AND REPORTS ON WELLS
Do not use this form for proposals to drill or to re-enter an
abandoned well. Use Form 3160-3 (APD) for such proposals.

5. Lease Serial No.
20G0005609

6. If Indian, Allottee or Tribe Name.

7. If Unit or CA/Agreement, Name and/or

8. Well Name and No.
UTE TRIBAL 4-8-5-2E

9. API Well No.
4304739716

10. Field and Pool, or Exploratory Area
MONUMENT BUTTE

11. County or Parish, State
UINTAH, UT

SUBMIT IN TRIPLICATE - Other Instructions on page 2

1. Type of Well
 Oil Well Gas Well Other

2. Name of Operator
NEWFIELD PRODUCTION COMPANY

3a. Address Route 3 Box 3630
Myton, UT 84052

3b. Phone (include are code)
435.646.3721

4. Location of Well (Footage, Sec., T., R., M., or Survey Description)
2146 FNL 700 FWL
NWNW Section 8 T5S R2E

12. CHECK APPROPRIATE BOX(ES) TO INIDICATE NATURE OF NOTICE, OR OTHER DATA

TYPE OF SUBMISSION	TYPE OF ACTION			
<input type="checkbox"/> Notice of Intent	<input type="checkbox"/> Acidize	<input type="checkbox"/> Deepen	<input type="checkbox"/> Production (Start/Resume)	<input type="checkbox"/> Water Shut-Off
<input checked="" type="checkbox"/> Subsequent Report	<input type="checkbox"/> Alter Casing	<input type="checkbox"/> Fracture Treat	<input type="checkbox"/> Reclamation	<input type="checkbox"/> Well Integrity
<input type="checkbox"/> Final Abandonment	<input type="checkbox"/> Casing Repair	<input type="checkbox"/> New Construction	<input type="checkbox"/> Recomplete	<input checked="" type="checkbox"/> Other _____
	<input type="checkbox"/> Change Plans	<input type="checkbox"/> Plug & Abandon	<input type="checkbox"/> Temporarily Abandon	Weekly Status Report
	<input type="checkbox"/> Convert to Injector	<input type="checkbox"/> Plug Back	<input type="checkbox"/> Water Disposal	

13. Describe Proposed or Completed Operation: (Clearly state all pertinent details, including estimated starting date of any proposed work and approximate duration thereof. If the proposal is to deepen directionally or recomplete horizontally, give subsurface locations and measured and true vertical depths of all pertinent markers and zones. Attach the Bond under which the work will be performed or provide the Bond No. on file with BLM/BIA. Required subsequent reports shall be filed within 30 days following completion of the involved operations. If the operation results in a multiple completion or recompletion in a new interval, a Form 3160-4 shall be filed once testing has been completed. Final Abandonment Notices shall be filed only after all requirements, including reclamation, have been completed, and the operator has determined that the site is ready for final inspection.)

On 8/10/08 MIRU Patterson Rig # 52. Set all equipment. Pressure test Kelly, TIW, Choke manifold, & Bop's to 2,000 psi. Test 8.625 csgn to 1,500 psi. Vernal BLM field, & Roosevelt DOGM office was notified of test. PU BHA and tag cement @ 279'. Drill out cement & shoe. Drill a 7.875 hole with fresh water to a depth of 6447'. Lay down drill string & BHA. Open hole log w/ Dig/SP/GR log's TD to surface. PU & TIH with Guide shoe, shoe jt, float collar, 163 jt's of 5.5 J-55, 15.5# csgn. Set @ 6433.24' KB. Cement with 400 sks cement mixed @ 11.0 ppg & 3.43 yld. The 490 sks cement mixed @ 14.4 ppg & 1.24 yld. Returned 40 bbls of cement to reserve pit. Nipple down Bop's. Drop slips @ 96,000 #s tension. Release rig @ 5:00 am 8/19/08.

I hereby certify that the foregoing is true and correct (Printed/ Typed) Don Bastian	Title Drilling Foreman
Signature <i>Don Bastian</i>	Date 08/19/2008

THIS SPACE FOR FEDERAL OR STATE OFFICE USE

Approved by _____	Title _____	Date _____
Conditions of approval, if any, are attached. Approval of this notice does not warrant or certify that the applicant holds legal or equitable title to those rights in the subject lease which would entitle the applicant to conduct operations thereon.	Office _____	

Title 18 U.S.C. Section 1001 and Title 43 U.S.C. Section 1212, make it a crime for any person knowingly and willfully to make to any department or agency of the United States any false, fictitious and fraudulent statements or representations as to any matter within its jurisdiction

RECEIVED

(Instructions on page 2)

AUG 20 2008

NEWFIELD PRODUCTION COMPANY - CASING & CEMENT REPORT

5 1/2" CASING SET AT 6433.24

Flt cllr @ 6412.7

LAST CASING 8 5/8" SET AT 333.06'

OPERATOR Newfield Production Company

DATUM 12' KB

WELL Ute Tribal 4-8-5-2E

DATUM TO CUT OFF CASING 12'

FIELD/PROSPECT Monument Butte

DATUM TO BRADENHEAD FLANGE _____

CONTRACTOR & RIG # Patterson Rig # 52

TD DRILLER 6450 Logger

HOLE SIZE 7 7/8"

LOG OF CASING STRING:							
PIECES	OD	ITEM - MAKE - DESCRIPTION	WT / FT	GRD	THREAD	CONDT	LENGTH
		Landing Jt					14
		6.90'(short jt @ 4345)					
162	5 1/2"	ETC LT & C casing	15.5#	J-55	8rd	A	6399.45
		Float collar					0.6
1	5 1/2"	ETC LT&C csg	15.5#	J-55	8rd	A	20.54
		GUIDE shoe			8rd	A	0.65
CASING INVENTORY BAL.		FEET	JTS	TOTAL LENGTH OF STRING			6435.24
TOTAL LENGTH OF STRING		6435.24	163	LESS CUT OFF PIECE			14
LESS NON CSG. ITEMS		15.25		PLUS DATUM TO T/CUT OFF CSG			12
PLUS FULL JTS. LEFT OUT		239.99	6	CASING SET DEPTH			6433.24
TOTAL		6659.98	169	} COMPARE			
TOTAL CSG. DEL. (W/O THRDS)		6659.98	169				
TIMING		1ST STAGE	2nd STAGE				
BEGIN RUN CSG.		2:30 PM	8/18/2008	GOOD CIRC THRU JOB			Yes
CSG. IN HOLE		7:30 PM	8/18/2008	Bbls CMT CIRC TO SURFACE			40
BEGIN CIRC		8:00 PM	8/18/2008	RECIPROCATED PIPE FOR			THRUSTROKE NO
BEGIN PUMP CMT		9:41 PM	8/18/2008	DID BACK PRES. VALVE HOLD ?			Yes
BEGIN DSPL. CMT		10:56 PM	8/18/2008	BUMPED PLUG TO			2570 PSI
PLUG DOWN		11:21 PM	8/18/2008				
CEMENT USED		B. J.					
STAGE	# SX						
1	400	Premlite II w/ 10% gel + 3 % KCL, 3#s /sk CSE + 2# sk/kolseal + 1/2#s/sk Cello Flake					
		mixed @ 11.0 ppg W / 3.49 cf/sk yield					
2	490	50/50 poz W/ 2% Gel + 3% KCL, .5%EC1,1/4# sk C.F. 2% gel. 3% SM mixed @ 14.4 ppg W/ 1.24 YLD					
CENTRALIZER & SCRATCHER PLACEMENT			SHOW MAKE & SPACING				
Centralizers - Middle first, top second & third. Then every third collar for a total of 20.							

COMPANY REPRESENTATIVE Jay Burton

DATE 8/16/2008

(See other instructions on reverse side)

OMB NO. 1004-0137
Expires: February 28, 1995

**UNITED STATES
DEPARTMENT OF THE INTERIOR
BUREAU OF LAND MANAGEMENT**

WELL COMPLETION OR RECOMPLETION REPORT AND LOG*

5. LEASE DESIGNATION AND SERIAL NO.

20G0005609

6. IF INDIAN, ALLOTTEE OR TRIBE NAME

UTE TRIBAL

7. UNIT AGREEMENT NAME

NA

8. FARM OR LEASE NAME, WELL NO.

UTE TRIBAL 4-8-5-2E

9. WELL NO.

43-04739716

10. FIELD AND POOL OR WILDCAT

Monument Butte

11. SEC., T., R., M., OR BLOCK AND SURVEY OR AREA

Sec. 8, T5S, R2E

1a. TYPE OF WORK

OIL WELL GAS WELL DRY Other _____

1b. TYPE OF WELL

NEW WELL WORK OVER DEEPEN PLUG BACK DIFF RESVR. Other _____

2. NAME OF OPERATOR

Newfield Exploration Company

3. ADDRESS AND TELEPHONE NO.

1401 17th St. Suite 1000 Denver, CO 80202

4. LOCATION OF WELL (Report locations clearly and in accordance with any State requirements.)*

At Surface 2146' FNL & 700' FWL (SW/NW) Sec. 8, T5S, R2E

At top prod. Interval reported below

At total depth

1400 FNL 696 FWL

14. API NO. 43-04739716 DATE ISSUED 10/26/08
per HSM review

12. COUNTY OR PARISH Uintah

13. STATE UT

15. DATE SPUDDED 8/7/08

16. DATE T.D. REACHED 8/17/08

17. DATE COMPL. (Ready to prod.) 9/26/08

18. ELEVATIONS (DF, RKB, RT, GR, ETC.)* 4856' GL

19. ELEV. CASINGHEAD 4868' KB

19. ELEV. CASINGHEAD

20. TOTAL DEPTH, MD & TVD

6447' 6237

21. PLUG BACK T.D., MD & TVD

6411' 6209

22. IF MULTIPLE COMPL., HOW MANY*

23. INTERVALS DRILLED BY ----->

ROTARY TOOLS

X

CABLE TOOLS

24. PRODUCING INTERVAL(S), OF THIS COMPLETION--TOP, BOTTOM, NAME (MD AND TVD)*

Green River 4576-6248'

25. WAS DIRECTIONAL SURVEY MADE
Yes

26. TYPE ELECTRIC AND OTHER LOGS RUN

Dual Induction Guard, SP, Compensated Density, Compensated Neutron, GR, Caliper, Cement Bond Log

27. WAS WELL CORED
No

23. CASING RECORD (Report all strings set in well)

CASING SIZE/GRADE	WEIGHT, LB./FT.	DEPTH SET (MD)	HOLE SIZE	TOP OF CEMENT, CEMENTING RECORD	AMOUNT PULLED
8-5/8" - J-55	24#	325.46'	12-1/4"	To surface with 160 sx Class "G" cmt	
5-1/2" - J-55	15.5#	6433.24	7-7/8"	400 sx Premilite II and 490 sx 50/50 Poz	

29. LINER RECORD

SIZE	TOP (MD)	BOTTOM (MD)	SACKS CEMENT*	SCREEN (MD)

30. TUBING RECORD

SIZE	DEPTH SET (MD)	PACKER SET (MD)
2-7/8"	EOT @ 6270'	TA @ 6135'

31. PERFORATION RECORD (Interval, size and number)

INTERVAL	SIZE	SPF/NUMBER	DEPTH INTERVAL (MD)	AMOUNT AND KIND OF MATERIAL USED
(BLS) 6182-6200', 6204-6248'	.49"	1/220 (2 RUNS)	6182-6246'	Frac w/ 60177# 20/40 sand in 941 bbls fluid
(D1) 5020-26', (DS3) 4980-4990'	.49"	4/64	4980-5026'	Frac w/ 40722# 20/40 sand in 402 bbls fluid
(DS2) 4906-4920'	.49"	4/56	4906-4920'	Frac w/ 35888# 20/40 sand in 359 bbls fluid
(GB6) 4576-4596'	.49"	4/20	4576-4596'	Frac w/ 41794# 20/40 sand in 514 bbls fluid

33.* PRODUCTION

DATE FIRST PRODUCTION 9/26/08	PRODUCTION METHOD (Flowing, gas lift, pumping--size and type of pump) 2-1/2" x 1-1/2" x 16' x 20' RHAC Pump w/ SM Plunger					WELL STATUS (Producing or shut-in) PRODUCING	
DATE OF TEST 9/27/08	HOURS TESTED	CHOKE SIZE	PROD'N. FOR TEST PERIOD	OIL--BBL. 107	GAS--MCF. 60	WATER--BBL. 153	GAS-OIL RATIO 561
FLOW. TUBING PRESS.	CASING PRESSURE	CALCULATED 24-HOUR RATE	OIL--BBL.	GAS--MCF.	WATER--BBL.	OIL GRAVITY-API (CORR.)	

34. DISPOSITION OF GAS (Sold, used for fuel, vented, etc.)

Sold & Used for Fuel

TEST WITNESSED BY

35. LIST OF ATTACHMENTS

36. I hereby certify that the foregoing and attached information is complete and correct as determined from all available records.

SIGNED Tammi Lee TITLE Production Clerk DATE 10/8/2008

*(See Instructions and Spaces for Additional Data on Reverse Side)

RECEIVED
OCT 14 2008

DIV. OF OIL, GAS & MINING

37. SUMMARY OF POROUS ZONES: (Show all important zones of porosity and contents thereof; cored intervals, and all drill-stem, tests, including depth interval tested, cushion used, time tool open, flowing and shut-in pressures, and recoveries);

FORMATION	TOP	BOTTOM	DESCRIPTION, CONTENTS, ETC.	GEOLOGIC MARKERS		
				NAME	MEAS. DEPTH	TRUE VERT. DEPTH
			Well Name UTE TRIBAL 4-8-5-2E			
				Garden Gulch Mkr	4074'	
				Garden Gulch 1	4236'	
				Garden Gulch 2	4345'	
				Point 3 Mkr	4601'	
				X Mkr	4824'	
				Y-Mkr	4861'	
				Douglas Creek Mkr	5011'	
				BiCarbonate Mkr	5313'	
				B Limestone Mkr	5433'	
				Castle Peak	5778'	
				Basal Carbonate	6169'	
				Wasatch	6280'	
				Total Depth (LOGGERS)	6468'	

38.

NEWFIELD



NEWFIELD EXPLORATION

USGS Myton SW (UT)

UTE SEC 8

UTE TRIBAL 4-8-5-2

Wellbore #1

Survey: Survey #1

Standard Survey Report


20 August, 2008

HATHAWAY ^{HB} _{HB} BURNHAM
DIRECTIONAL & MWD SERVICES



Hathaway Burnham

Survey Report

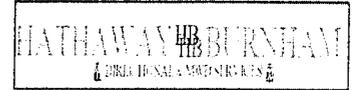

Company: NEWFIELD EXPLORATION
 Project: USGS Myton SW (UT)
 Site: UTE SEC 8
 Well: UTE TRIBAL 4-8-5-2
 Wellbore: Wellbore #1
 Design: Wellbore #1

Local Co-ordinate Reference: Well UTE TRIBAL 4-8-5-2
 TVD Reference: 4-8-5-2 @ 4866.0ft (PATTERSON 52)
 MD Reference: 4-8-5-2 @ 4866.0ft (PATTERSON 52)
 North Reference: True
 Survey Calculation Method: Minimum Curvature
 Database: EDM 2003.21 Single User Db

Project	USGS Myton SW (UT), DUCHESNE COUNTY, UT, USA		
Map System:	US State Plane 1983	System Datum:	Mean Sea Level
Geo Datum:	North American Datum 1983		
Map Zone:	Utah Central Zone	Using geodetic scale factor	

Site UTE SEC 8, SEC 8, T5S, R2E

Site Position:
From: Lat/Long **Northing:** 7,196,540.00ft **Latitude:** 40° 3' 50.219 N
Position Uncertainty: 0.0ft **Easting:** 2,116,231.58ft **Longitude:** 109° 47' 59.287 W
Slot Radius: " **Grid Convergence:** 1.09°

Well UTE TRIBAL 4-8-5-2
Well Position +N/-S 0.0ft **Northing:** 7,197,061.25ft **Latitude:** 40° 3' 55.370 N
 +E/-W 0.0ft **Easting:** 2,116,231.58ft **Longitude:** 109° 47' 59.160 W
Position Uncertainty 0.0ft **Wellhead Elevation:** ft **Ground Level:** 0.0ft

Wellbore Wellbore #1

Magnetics	Model Name	Sample Date	Declination (°)	Dip Angle (°)	Field Strength (nT)
	IGRF200510	8/8/2008	11.56	65.94	52,632

Design Wellbore #1

Audit Notes:

Version: 1.0 **Phase:** ACTUAL **Tie On Depth:** 0.0

Vertical Section:	Depth From (TVD) (ft)	+N/-S (ft)	+E/-W (ft)	Direction (°)
	0.0	0.0	0.0	358.65

Survey Program Date 8/20/2008

From (ft)	To (ft)	Survey (Wellbore)	Tool Name	Description
389.0	6,445.0	Survey #1 (Wellbore #1)	MWD	MWD - Standard

Survey

Measured Depth (ft)	Inclination (°)	Azimuth (°)	Vertical Depth (ft)	+N/-S (ft)	+E/-W (ft)	Vertical Section (ft)	Dogleg Rate (°/100ft)	Build Rate (°/100ft)	Turn Rate (°/100ft)
0.0	0.00	0.00	0.0	0.0	0.0	0.0	0.00	0.00	0.00
50.0	0.09	94.00	50.0	0.0	0.0	0.0	0.18	0.18	0.00
100.0	0.18	94.00	100.0	0.0	0.2	0.0	0.18	0.18	0.00
150.0	0.27	94.00	150.0	0.0	0.4	0.0	0.18	0.18	0.00
200.0	0.36	94.00	200.0	0.0	0.6	-0.1	0.18	0.18	0.00
250.0	0.45	94.00	250.0	-0.1	1.0	-0.1	0.18	0.18	0.00
300.0	0.54	94.00	300.0	-0.1	1.4	-0.1	0.18	0.18	0.00
350.0	0.63	94.00	350.0	-0.1	1.9	-0.2	0.18	0.18	0.00
400.0	0.62	88.20	400.0	-0.2	2.5	-0.2	0.13	-0.02	-11.60
450.0	0.70	11.60	450.0	0.1	2.9	0.0	1.64	0.16	-153.20
500.0	0.97	347.49	500.0	0.8	2.8	0.7	0.88	0.55	-48.21
550.0	1.43	355.63	550.0	1.8	2.7	1.8	0.96	0.90	16.27
600.0	1.59	350.95	600.0	3.1	2.5	3.1	0.40	0.32	-9.36



Company: NEWFIELD EXPLORATION
 Project: USGS Myton SW (UT)
 Site: UTE SEC 8
 Well: UTE TRIBAL 4-8-5-2
 Wellbore: Wellbore #1
 Design: Wellbore #1

Local Co-ordinate Reference: Well UTE TRIBAL 4-8-5-2
 TVD Reference: 4-8-5-2 @ 4866.0ft (PATTERSON 52)
 MD Reference: 4-8-5-2 @ 4866.0ft (PATTERSON 52)
 North Reference: True
 Survey Calculation Method: Minimum Curvature
 Database: EDM 2003.21 Single User Db

Survey

Measured Depth (ft)	Inclination (°)	Azimuth (°)	Vertical Depth (ft)	+N/-S (ft)	+E/-W (ft)	Vertical Section (ft)	Dogleg Rate (°/100ft)	Build Rate (°/100ft)	Turn Rate (°/100ft)
650.0	2.10	343.67	649.9	4.6	2.1	4.5	1.12	1.02	-14.55
700.0	2.71	348.38	699.9	6.7	1.6	6.7	1.28	1.22	9.41
750.0	3.11	341.51	749.8	9.1	0.9	9.0	1.06	0.80	-13.75
800.0	3.56	345.50	799.7	11.8	0.1	11.8	1.01	0.90	7.98
850.0	4.01	347.54	849.6	15.1	-0.7	15.2	0.94	0.90	4.08
900.0	4.32	348.36	899.5	18.7	-1.5	18.7	0.63	0.62	1.65
950.0	4.50	351.86	949.3	22.5	-2.1	22.5	0.65	0.37	7.01
1,000.0	4.80	351.28	999.2	26.4	-2.7	26.5	0.61	0.60	-1.17
1,050.0	5.41	354.97	1,049.0	30.8	-3.3	30.9	1.38	1.21	7.39
1,100.0	6.16	355.84	1,098.7	35.9	-3.6	35.9	1.52	1.51	1.74
1,150.0	6.23	357.40	1,148.4	41.2	-3.8	41.3	0.37	0.14	3.11
1,200.0	6.94	0.61	1,198.1	46.9	-4.1	47.0	1.59	1.41	6.42
1,250.0	7.75	359.23	1,247.7	53.3	-4.0	53.4	1.66	1.62	-2.74
1,300.0	7.92	1.99	1,297.2	60.2	-4.0	60.3	0.83	0.35	5.51
1,350.0	8.56	0.25	1,346.7	67.3	-3.8	67.3	1.38	1.28	-3.47
1,400.0	9.74	359.54	1,396.1	75.3	-3.9	75.3	2.36	2.35	-1.42
1,450.0	10.84	0.62	1,445.3	84.1	-3.8	84.2	2.24	2.21	2.15
1,500.0	11.30	5.67	1,494.3	93.8	-3.3	93.8	2.14	0.91	10.11
1,550.0	11.83	11.32	1,543.3	103.6	-1.8	103.6	2.50	1.07	11.29
1,600.0	12.43	10.76	1,592.2	113.9	0.2	113.9	1.22	1.19	-1.13
1,650.0	13.15	7.08	1,641.0	124.8	2.0	124.7	2.18	1.45	-7.35
1,700.0	14.09	6.47	1,689.6	136.5	3.3	136.4	1.90	1.88	-1.22
1,750.0	15.04	4.62	1,738.0	149.0	4.5	148.9	2.11	1.89	-3.70
1,800.0	16.35	3.56	1,786.1	162.5	5.5	162.3	2.69	2.62	-2.13
1,850.0	16.68	0.00	1,834.0	176.7	5.9	176.5	2.12	0.65	-7.11
1,900.0	17.04	356.66	1,881.9	191.2	5.5	191.0	2.07	0.72	-6.70
1,950.0	17.67	355.95	1,929.6	206.1	4.5	205.9	1.33	1.26	-1.41
2,000.0	18.20	355.02	1,977.2	221.5	3.3	221.3	1.20	1.06	-1.86
2,050.0	18.19	352.65	2,024.7	237.0	1.7	236.9	1.48	-0.02	-4.74
2,100.0	18.12	350.94	2,072.2	252.4	-0.6	252.4	1.08	-0.14	-3.43
2,150.0	17.81	351.09	2,119.8	267.7	-3.0	267.6	0.63	-0.63	0.31
2,200.0	17.56	351.31	2,167.4	282.6	-5.4	282.7	0.50	-0.48	0.42
2,250.0	17.46	351.62	2,215.1	297.5	-7.6	297.6	0.28	-0.21	0.63
2,300.0	17.31	351.94	2,262.8	312.3	-9.7	312.5	0.36	-0.30	0.63
2,350.0	17.10	352.25	2,310.6	327.0	-11.8	327.1	0.46	-0.42	0.63
2,400.0	17.25	353.33	2,358.3	341.5	-13.7	341.8	0.71	0.30	2.16
2,450.0	17.72	354.99	2,406.0	356.5	-15.2	356.7	1.37	0.94	3.32
2,500.0	18.42	356.29	2,453.6	371.9	-16.3	372.2	1.62	1.40	2.60
2,550.0	19.26	357.33	2,500.9	388.0	-17.2	388.3	1.81	1.69	2.07
2,600.0	19.57	359.12	2,548.0	404.7	-17.8	405.0	1.34	0.60	3.60
2,650.0	19.68	1.22	2,595.1	421.5	-17.7	421.8	1.43	0.22	4.20
2,700.0	19.78	0.43	2,642.2	438.4	-17.4	438.6	0.58	0.21	-1.59
2,750.0	19.89	359.01	2,689.2	455.3	-17.5	455.6	0.99	0.22	-2.83
2,800.0	19.90	359.43	2,736.2	472.3	-17.8	472.6	0.29	0.02	0.84
2,850.0	19.91	0.03	2,783.3	489.4	-17.8	489.6	0.41	0.01	1.19
2,900.0	20.16	1.41	2,830.2	506.5	-17.6	506.8	1.08	0.52	2.77
2,950.0	20.30	2.35	2,877.1	523.8	-17.0	524.1	0.70	0.26	1.89
3,000.0	19.45	0.20	2,924.2	540.8	-16.6	541.0	2.24	-1.70	-4.30
3,050.0	18.59	358.13	2,971.4	557.1	-16.9	557.3	2.18	-1.71	-4.14
3,100.0	17.64	356.85	3,018.9	572.6	-17.5	572.9	2.06	-1.90	-2.57
3,150.0	16.91	355.49	3,066.7	587.4	-18.5	587.7	1.66	-1.45	-2.72
3,200.0	16.65	354.18	3,114.6	601.8	-19.8	602.1	0.92	-0.53	-2.62
3,250.0	16.75	354.89	3,162.5	616.0	-21.3	616.3	0.45	0.20	1.42
3,300.0	17.38	358.27	3,210.3	630.6	-22.2	630.9	2.35	1.26	6.75




Company: NEWFIELD EXPLORATION
 Project: USGS Myton SW (UT)
 Site: UTE SEC 8
 Well: UTE TRIBAL 4-8-5-2
 Wellbore: Wellbore #1
 Design: Wellbore #1

Local Co-ordinate Reference: Well UTE TRIBAL 4-8-5-2
 TVD Reference: 4-8-5-2 @ 4866.0ft (PATTERSON 52)
 MD Reference: 4-8-5-2 @ 4866.0ft (PATTERSON 52)
 North Reference: True
 Survey Calculation Method: Minimum Curvature
 Database: EDM 2003.21 Single User Db

Survey

Measured Depth (ft)	Inclination (°)	Azimuth (°)	Vertical Depth (ft)	+N/-S (ft)	+E/-W (ft)	Vertical Section (ft)	Dogleg Rate (°/100ft)	Build Rate (°/100ft)	Turn Rate (°/100ft)
3,350.0	17.70	0.16	3,258.0	645.7	-22.3	646.1	1.31	0.64	3.79
3,400.0	17.70	0.85	3,305.6	660.9	-22.2	661.3	0.42	0.00	1.38
3,450.0	17.43	1.00	3,353.2	676.1	-21.9	676.4	0.55	-0.54	0.30
3,500.0	17.01	0.84	3,401.0	690.9	-21.7	691.2	0.85	-0.84	-0.32
3,550.0	17.21	1.56	3,448.8	705.5	-21.4	705.8	0.58	0.40	1.44
3,600.0	17.63	2.55	3,496.5	720.5	-20.9	720.8	1.03	0.85	1.97
3,650.0	17.32	359.64	3,544.2	735.5	-20.5	735.8	1.86	-0.63	-5.81
3,700.0	16.92	355.83	3,592.0	750.2	-21.1	750.5	2.37	-0.79	-7.61
3,750.0	17.29	356.97	3,639.8	764.9	-22.0	765.2	1.00	0.74	2.26
3,800.0	17.68	358.37	3,687.5	779.9	-22.6	780.2	1.15	0.78	2.80
3,850.0	17.26	0.07	3,735.1	794.9	-22.9	795.2	1.33	-0.85	3.41
3,900.0	16.90	1.58	3,783.0	809.6	-22.6	809.9	1.14	-0.71	3.02
3,950.0	16.90	1.42	3,830.8	824.1	-22.2	824.4	0.09	0.00	-0.32
4,000.0	16.79	1.62	3,878.6	838.6	-21.9	838.9	0.26	-0.23	0.40
4,050.0	16.31	3.01	3,926.6	852.8	-21.3	853.1	1.23	-0.94	2.78
4,100.0	15.95	3.72	3,974.6	866.7	-20.4	866.9	0.83	-0.73	1.41
4,150.0	15.79	2.83	4,022.7	880.3	-19.7	880.5	0.58	-0.32	-1.78
4,200.0	15.77	2.05	4,070.8	893.9	-19.1	894.1	0.42	-0.05	-1.54
4,250.0	15.92	1.47	4,118.9	907.5	-18.7	907.7	0.45	0.32	-1.16
4,300.0	15.70	1.64	4,167.0	921.2	-18.3	921.4	0.45	-0.45	0.33
4,350.0	15.13	2.53	4,215.2	934.5	-17.9	934.7	1.24	-1.15	1.78
4,400.0	14.61	3.44	4,263.5	947.3	-17.2	947.4	1.13	-1.03	1.84
4,450.0	14.14	4.40	4,312.0	959.7	-16.3	959.8	1.06	-0.95	1.91
4,500.0	13.55	3.13	4,360.5	971.6	-15.5	971.7	1.33	-1.18	-2.54
4,550.0	12.92	0.71	4,409.2	983.1	-15.1	983.2	1.67	-1.25	-4.84
4,600.0	13.68	0.93	4,457.9	994.5	-15.0	994.5	1.52	1.52	0.44
4,650.0	14.79	1.73	4,506.3	1,006.8	-14.7	1,006.8	2.25	2.21	1.59
4,700.0	15.13	359.90	4,554.6	1,019.7	-14.5	1,019.8	1.16	0.68	-3.65
4,750.0	15.40	357.96	4,602.9	1,032.9	-14.7	1,032.9	1.15	0.53	-3.87
4,800.0	15.33	1.22	4,651.1	1,046.1	-14.8	1,046.2	1.73	-0.15	6.51
4,850.0	15.39	3.92	4,699.3	1,059.3	-14.2	1,059.3	1.44	0.14	5.40
4,900.0	16.18	2.51	4,747.4	1,072.9	-13.4	1,072.9	1.75	1.57	-2.82
4,950.0	16.74	1.32	4,795.4	1,087.1	-13.0	1,087.1	1.31	1.12	-2.38
5,000.0	16.48	0.48	4,843.3	1,101.4	-12.7	1,101.4	0.71	-0.53	-1.67
5,050.0	16.43	359.57	4,891.2	1,115.5	-12.7	1,115.5	0.52	-0.09	-1.83
5,100.0	16.85	358.57	4,939.1	1,129.8	-13.0	1,129.8	1.01	0.83	-1.99
5,150.0	16.86	359.00	4,987.0	1,144.4	-13.4	1,144.4	0.25	0.02	0.85
5,200.0	16.28	1.62	5,034.9	1,158.7	-13.3	1,158.6	1.89	-1.16	5.24
5,250.0	15.94	4.09	5,082.9	1,172.5	-12.6	1,172.4	1.53	-0.68	4.95
5,300.0	15.84	6.31	5,131.0	1,186.1	-11.4	1,186.0	1.23	-0.21	4.43
5,350.0	15.83	6.73	5,179.1	1,199.6	-9.7	1,199.5	0.23	-0.01	0.84
5,400.0	15.88	5.95	5,227.2	1,213.2	-8.2	1,213.1	0.44	0.10	-1.56
5,450.0	15.89	7.23	5,275.3	1,226.8	-6.7	1,226.6	0.70	0.02	2.57
5,500.0	15.90	9.48	5,323.4	1,240.4	-4.7	1,240.1	1.23	0.01	4.51
5,550.0	15.80	8.65	5,371.5	1,253.8	-2.5	1,253.6	0.49	-0.19	-1.67
5,600.0	15.70	7.30	5,419.6	1,267.3	-0.6	1,266.9	0.76	-0.21	-2.70
5,650.0	14.80	8.84	5,467.9	1,280.3	1.2	1,279.9	1.97	-1.80	3.09
5,700.0	14.03	10.35	5,516.3	1,292.5	3.3	1,292.1	1.72	-1.55	3.00
5,750.0	14.29	9.81	5,564.8	1,304.6	5.4	1,304.1	0.59	0.53	-1.07
5,800.0	14.60	8.90	5,613.2	1,316.9	7.5	1,316.3	0.77	0.62	-1.82
5,850.0	15.11	6.52	5,661.5	1,329.6	9.2	1,329.0	1.60	1.03	-4.77
5,900.0	15.59	4.61	5,709.8	1,342.7	10.4	1,342.1	1.38	0.95	-3.82
5,950.0	15.90	3.60	5,757.9	1,356.3	11.4	1,355.6	0.83	0.63	-2.01
6,000.0	16.14	2.61	5,805.9	1,370.1	12.2	1,369.4	0.72	0.47	-1.98

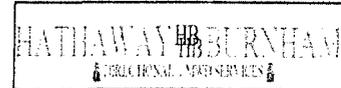

Company: NEWFIELD EXPLORATION
 Project: USGS Myton SW (UT)
 Site: UTE SEC 8
 Well: UTE TRIBAL 4-8-5-2
 Wellbore: Wellbore #1
 Design: Wellbore #1

Local Co-ordinate Reference: Well UTE TRIBAL 4-8-5-2
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 MD Reference: 4-8-5-2 @ 4866.0ft (PATTERSON 52)
 North Reference: True
 Survey Calculation Method: Minimum Curvature
 Database: EDM 2003.21 Single User Db

Survey

Measured Depth (ft)	Inclination (°)	Azimuth (°)	Vertical Depth (ft)	+N/-S (ft)	+E/-W (ft)	Vertical Section (ft)	Dogleg Rate (°/100ft)	Build Rate (°/100ft)	Turn Rate (°/100ft)
6,050.0	16.25	1.60	5,853.9	1,384.0	12.7	1,383.3	0.60	0.21	-2.02
6,100.0	16.13	0.06	5,901.9	1,398.0	12.9	1,397.3	0.89	-0.22	-3.07
6,150.0	15.82	357.93	5,950.0	1,411.8	12.7	1,411.1	1.33	-0.64	-4.27
6,200.0	15.46	355.77	5,998.2	1,425.2	11.9	1,424.5	1.36	-0.70	-4.32
6,250.0	15.10	353.54	6,046.4	1,438.3	10.7	1,437.7	1.38	-0.73	-4.46
6,300.0	14.70	352.57	6,094.7	1,451.1	9.1	1,450.5	0.94	-0.80	-1.94
6,305.5	14.65	352.52	6,100.1	1,452.5	8.9	1,451.9	0.87	-0.83	-0.93
4-8-5-2 TGT									
6,350.0	14.28	352.10	6,143.1	1,463.5	7.5	1,462.9	0.87	-0.83	-0.95
6,400.0	13.70	350.00	6,191.6	1,475.4	5.6	1,474.9	1.55	-1.17	-4.20

Checked By: _____ Approved By: _____ Date: _____

H HEADER INFORMATION-----
 H COMPANY: NEWFIELD EXPLORATION
 H FIELD : USGS Myton SW (UT)
 H SITE : UTE SEC 8
 H WELL : UTE TRIBAL 4-8-5-2
 H WELLPAT Wellbore #1
 H DEPTHUN ft
 H SURVDAT 8/18/2008
 H DECLINAT CORR.
 H = 10.47 TO GRIDH-----

H WELL INFORMATION
 H WELL EW MAP : 2116232
 H WELL NS MAP : 7197061
 H DATUM ELEVN : 4866
 H VSECT ANGLE : 358.65
 H VSECT NORTH : 0
 H VSECT EAST : 0

H-----
 H SURVEY TYPE INFORMATION
 H 389 - 6445 SURVEY #1 : MWD
 H-----

H	SURVEY LIST							
MDS	INC	AZI	TVD	NS	EW	VS	DLS	
	0	0	0	0	0	0	0	0
	389	0.7	94	388.99	-0.17	2.37	-0.22	0.18
	420	0.5	73.3	419.99	-0.14	2.69	-0.2	0.94
	450	0.7	11.6	449.99	0.08	2.85	0.01	2.13
	481	0.8	359.3	480.98	0.48	2.89	0.41	0.61
	512	1.1	342.1	511.98	0.98	2.79	0.91	1.32
	542	1.4	355.9	541.97	1.62	2.68	1.55	1.41
	573	1.5	354.9	572.96	2.4	2.61	2.34	0.33
	604	1.6	350.4	603.95	3.23	2.51	3.17	0.51
	634	1.8	336.8	633.94	4.08	2.25	4.02	1.5
	665	2.4	348.5	664.92	5.16	1.93	5.11	2.37
	696	2.7	349.6	695.89	6.51	1.67	6.47	0.98
	727	2.8	340.4	726.85	7.95	1.28	7.91	1.46
	757	3.2	341.8	756.81	9.43	0.78	9.41	1.36
	788	3.2	343.7	787.76	11.08	0.26	11.07	0.34
	818	4.1	347.6	817.7	12.94	-0.2	12.94	3.11
	849	4	347.6	848.62	15.07	-0.67	15.09	0.32
	881	4.2	345.7	880.54	17.3	-1.2	17.32	0.76
	913	4.4	350.1	912.45	19.64	-1.7	19.68	1.21
	945	4.5	351.8	944.36	22.1	-2.09	22.14	0.52
	976	4.5	352.2	975.26	24.5	-2.43	24.55	0.1
	1008	4.9	351	1007.15	27.1	-2.82	27.16	1.29
	1039	5.2	354.2	1038.03	29.8	-3.16	29.87	1.33
	1071	5.8	356.3	1069.88	32.86	-3.42	32.93	1.98
	1103	6.2	355.8	1101.71	36.2	-3.65	36.27	1.26
	1135	6.1	359.8	1133.53	39.62	-3.78	39.7	1.37

1167	6.4	354.8	1165.34	43.1	-3.95	43.18	1.94
1198	6.9	0.6	1196.13	46.68	-4.08	46.76	2.7
1230	7.5	0.7	1227.87	50.69	-4.04	50.77	1.88
1262	7.9	358.4	1259.59	54.98	-4.07	55.06	1.58
1293	7.9	1.9	1290.29	59.23	-4.06	59.31	1.55
1325	8	2.3	1321.98	63.66	-3.9	63.73	0.36
1356	8.7	359.8	1352.66	68.16	-3.82	68.23	2.54
1389	9.6	358.8	1385.24	73.4	-3.89	73.48	2.77
1421	10	0.9	1416.77	78.85	-3.9	78.92	1.68
1452	10.9	0.6	1447.25	84.47	-3.83	84.54	2.91
1485	11.4	3.9	1479.63	90.85	-3.57	90.91	2.46
1516	11.2	7.6	1510.03	96.89	-2.97	96.93	2.43
1548	11.8	11.3	1541.39	103.18	-1.91	103.19	2.97
1580	12.3	11.6	1572.68	109.72	-0.59	109.71	1.57
1611	12.5	10.3	1602.96	116.26	0.68	116.21	1.11
1643	13	7.4	1634.17	123.24	1.76	123.16	2.54
1675	13.7	6	1665.31	130.57	2.62	130.48	2.41
1707	14.2	6.6	1696.36	138.24	3.47	138.12	1.63
1738	14.7	4.7	1726.38	145.94	4.22	145.8	2.22
1770	15.6	4.5	1757.27	154.27	4.9	154.12	2.82
1802	16.4	3.5	1788.03	163.07	5.51	162.9	2.64
1897	17	356.7	1879.03	190.33	5.53	190.14	2.15
1992	18.2	355.4	1969.58	218.98	3.54	218.84	1.33
2087	18.2	350.9	2059.84	248.42	0	248.35	1.48
2183	17.6	351.2	2151.19	277.57	-4.59	277.6	0.63
2278	17.4	351.8	2241.79	305.82	-8.81	305.94	0.28
2373	17	352.4	2332.54	333.64	-12.68	333.85	0.46
2469	17.9	355.6	2424.13	362.27	-15.66	362.53	1.37
2564	19.5	357.6	2514.11	392.67	-17.45	392.97	1.81
2659	19.7	1.6	2603.61	424.52	-17.66	424.81	1.43
2754	19.9	358.9	2692.99	456.69	-17.53	456.97	0.99
2849	19.9	0	2782.32	489.02	-17.84	489.3	0.39
2944	20.4	2.6	2871.51	521.73	-17.09	521.99	1.08
3039	18.8	358.4	2961.01	553.57	-16.76	553.82	2.24
3134	17	355.9	3051.4	582.73	-18.18	583	2.06
3229	16.5	353.4	3142.37	609.99	-20.73	610.3	0.92
3324	17.7	359.8	3233.18	637.83	-22.33	638.18	2.35
3418	17.7	1.1	3322.73	666.41	-22.1	666.74	0.42
3513	16.9	0.8	3413.43	694.65	-21.63	694.97	0.85
3608	17.7	2.7	3504.14	722.89	-20.76	723.18	1.03
3703	16.9	355.6	3594.85	751.08	-21.14	751.37	2.37
3798	17.7	358.3	3685.55	779.29	-22.63	779.6	1.19
3893	16.9	1.6	3776.25	807.53	-22.67	807.84	1.33
3988	16.9	1.3	3867.15	835.14	-21.97	835.42	0.09
4084	16	4	3959.22	862.28	-20.73	862.53	1.23
4179	15.7	2.3	4050.61	888.19	-19.3	888.4	0.58
4274	16	1.2	4142	914.12	-18.51	914.3	0.45
4370	14.9	2.9	4234.53	939.68	-17.61	939.83	1.24
4465	14	4.7	4326.52	963.33	-16.05	963.44	1.06





				NS	EW		
4560	12.8	0.2	4418.94	985.31	-15.07	985.39	1.67
4655	14.9	1.8	4511.17	1008.04	-14.65	1008.11	2.25
4749	15.4	357.9	4601.91	1032.59	-14.73	1032.65	1.21
4844	15.3	4.1	4693.52	1057.7	-14.3	1057.75	1.73
4939	16.8	1.5	4784.82	1083.93	-13.04	1083.94	1.75
5034	16.3	359.9	4875.88	1110.99	-12.71	1110.98	0.71
5130	17.1	358	4967.83	1138.56	-13.22	1138.56	1.01
5225	16	3	5058.9	1165.6	-13.02	1165.58	1.89
5320	15.8	7.2	5150.27	1191.51	-10.72	1191.43	1.23
5416	15.9	5.7	5242.62	1217.56	-7.77	1217.4	0.44
5507	15.9	9.8	5330.14	1242.25	-4.41	1242.01	1.23
5600	15.7	7.3	5419.63	1267.28	-0.65	1266.94	0.76
5695	14	10.4	5511.45	1291.33	3.06	1290.9	1.97
5790	14.5	9.4	5603.53	1314.37	7.08	1313.84	0.59
5886	15.5	4.9	5696.26	1339.01	10.14	1338.4	1.6
5981	16.1	3	5787.67	1364.81	11.91	1364.15	0.83
6075	16.3	1.1	5877.94	1391.02	12.85	1390.33	0.6
6169	15.7	357.1	5968.3	1416.91	12.46	1416.22	1.33
6264	15	352.9	6059.92	1441.95	10.29	1441.3	1.38
6360	14.2	352	6152.81	1465.93	7.11	1465.36	0.87
6395	13.7	350	6186.78	1474.27	5.79	1473.72	1.98
6445	13.7	350	6235.36	1485.93	3.74	1485.43	0



Project: USGS Myton SW (UT)
 Site: UTE SEC 8
 Well: UTE TRIBAL 4-8-5-2
 Wellbore: Wellbore #1
 Design: Wellbore #1

FINAL SURVEY REPORT

Azimuths to True North
 Magnetic North: 11.56°
 Magnetic Field
 Strength: 52631.9snT
 Dip Angle: 65.94°
 Date: 8/8/2008
 Model: IGRF200510

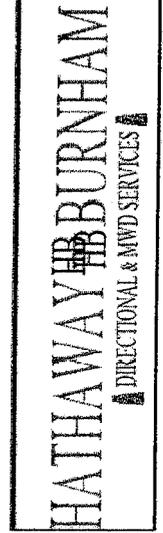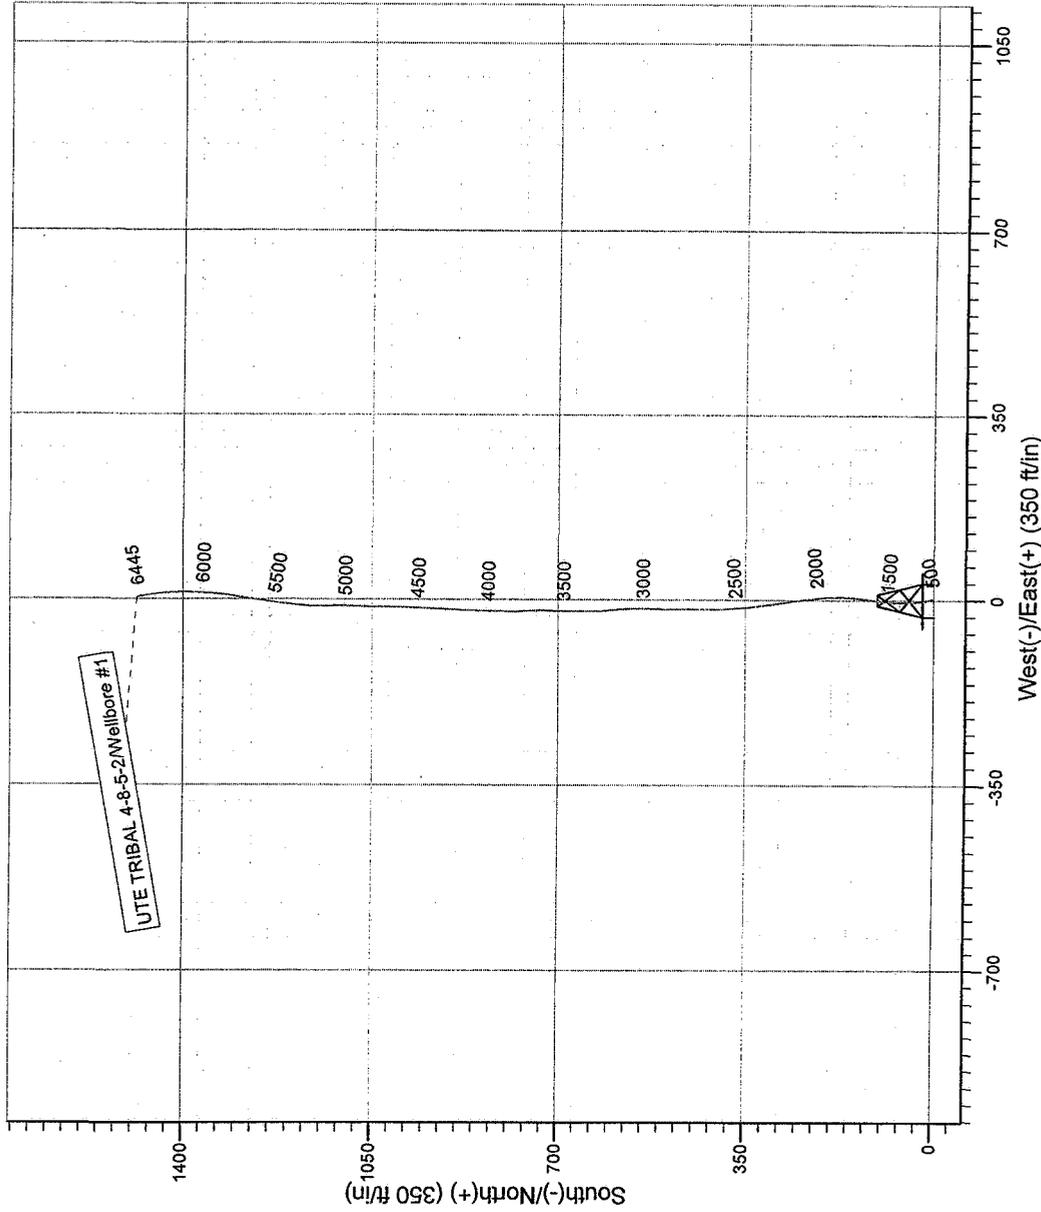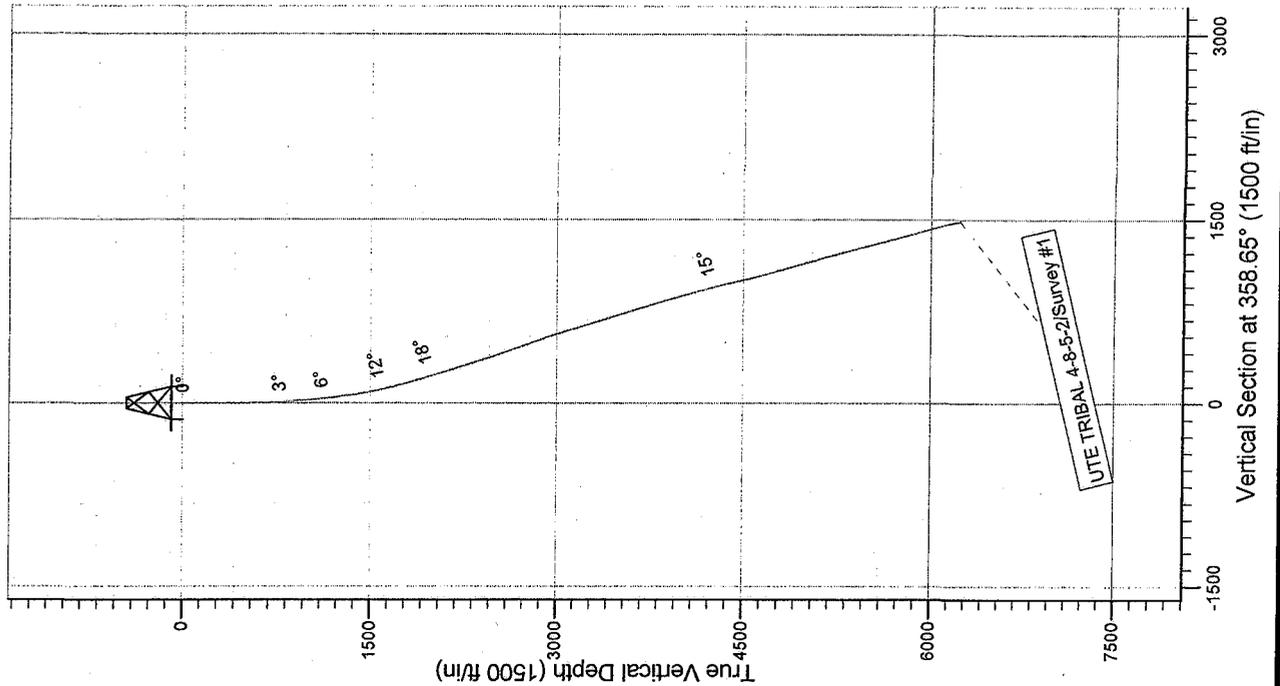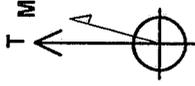

Survey: Survey #1 (UTE TRIBAL 4-8-5-2/Wellbore #1)

Created By: *Jim Hudson* Date: 8:26, August 20 2008

THIS SURVEY IS CORRECT TO THE BEST OF MY KNOWLEDGE AND IS SUPPORTED BY ACTUAL FIELD DATA.

STATE OF UTAH
DEPARTMENT OF NATURAL RESOURCES
DIVISION OF OIL, GAS AND MINING

SUNDRY NOTICES AND REPORTS ON WELLS

Do not use this form for proposals to drill new wells, significantly deepen existing wells below current bottom-hole depth, reenter plugged wells, or to drill horizontal laterals. Use APPLICATION FOR PERMIT TO DRILL form for such proposals.

5. LEASE DESIGNATION AND SERIAL NUMBER: FEE
6. IF INDIAN, ALLOTTEE OR TRIBE NAME: <u>20030005009</u>
7. UNIT or CA AGREEMENT NAME:
8. WELL NAME and NUMBER: UTE TRIBAL 4-8-5-2E
9. API NUMBER: 4304739716
10. FIELD AND POOL, OR WILDCAT: MONUMENT BUTTE


1. TYPE OF WELL: OIL WELL <input checked="" type="checkbox"/> GAS WELL <input type="checkbox"/> OTHER	
2. NAME OF OPERATOR: NEWFIELD PRODUCTION COMPANY	
3. ADDRESS OF OPERATOR: Route 3 Box 3630 CITY Myton STATE UT ZIP 84052	PHONE NUMBER 435.646.3721
4. LOCATION OF WELL: FOOTAGES AT SURFACE: 2146 FNL 700 FWL OTR/OTR. SECTION. TOWNSHIP. RANGE. MERIDIAN: NWNW, 8, T5S, R2E	

COUNTY: UINTAH
STATE: UT

11. CHECK APPROPRIATE BOXES TO INDICATE NATURE OF NOTICE, REPORT, OR OTHER DATA

TYPE OF SUBMISSION	TYPE OF ACTION		
<input type="checkbox"/> NOTICE OF INTENT (Submit in Duplicate) Approximate date work will _____	<input type="checkbox"/> ACIDIZE	<input type="checkbox"/> DEEPEN	<input type="checkbox"/> REPERFORATE CURRENT FORMATION
	<input type="checkbox"/> ALTER CASING	<input type="checkbox"/> FRACTURE TREAT	<input type="checkbox"/> SIDETRACK TO REPAIR WELL
	<input type="checkbox"/> CASING REPAIR	<input type="checkbox"/> NEW CONSTRUCTION	<input type="checkbox"/> TEMPORARILY ABANDON
	<input type="checkbox"/> CHANGE TO PREVIOUS PLANS	<input type="checkbox"/> OPERATOR CHANGE	<input type="checkbox"/> TUBING REPAIR
	<input type="checkbox"/> CHANGE TUBING	<input type="checkbox"/> PLUG AND ABANDON	<input type="checkbox"/> VENT OR FLAIR
<input checked="" type="checkbox"/> SUBSEQUENT REPORT (Submit Original Form Only) Date of Work Completion: <u>10/09/2008</u>	<input type="checkbox"/> CHANGE WELL NAME	<input type="checkbox"/> PLUG BACK	<input type="checkbox"/> WATER DISPOSAL
	<input type="checkbox"/> CHANGE WELL STATUS	<input type="checkbox"/> PRODUCTION (START/STOP)	<input type="checkbox"/> WATER SHUT-OFF
	<input type="checkbox"/> COMMINGLE PRODUCING FORMATIONS	<input type="checkbox"/> RECLAMATION OF WELL SITE	<input checked="" type="checkbox"/> OTHER: - Weekly Status Report
	<input type="checkbox"/> CONVERT WELL TYPE	<input type="checkbox"/> RECOMPLETE - DIFFERENT FORMATION	

12. DESCRIBE PROPOSED OR COMPLETED OPERATIONS. Clearly show all pertinent details including dates, depths, volumes, etc.
The above subject well was completed on 09-26-08, attached is a daily completion status report.

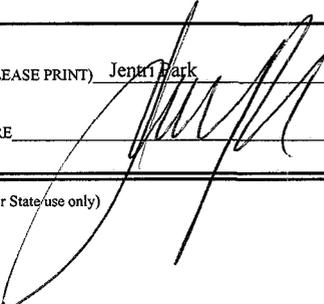NAME (PLEASE PRINT) <u>Jennifer Mark</u>	TITLE <u>Production Clerk</u>
SIGNATURE 	DATE <u>10/09/2008</u>

(This space for State use only)

RECEIVED
OCT 16 2008
DIV. OF OIL, GAS & MINING

Daily Activity Report

Format For Sundry

UTE TRIBAL 4-8-5-2E

7/1/2008 To 11/30/2008

9/13/2008 Day: 1**Completion**

Rigless on 9/12/2008 - Install 5M frac head. NU 6" 5M Cameron BOP. RU H/O truck & pressure test casing, blind rams, frac head & casing valves to 4500 psi. RU Perforators LLC WLT w/ mast & run CBL under pressure. WLTD @ 6328' cement top @ 20'. Perforate stage #1. BSL Carb @ 6182- 6200', 6204- 48' w/ 3 1/8" slick guns (19 gram, .49" HE, 120°, 21.92" pen, EXP-3319-331 Titan) w/ 4 spf for total of 220 shots (2 runs). 153 BWTR. SIFN.

9/18/2008 Day: 2**Completion**

Rigless on 9/17/2008 - RU BJ Services "Ram Head" frac flange. RU BJ & frac BSL sds, stage #1 down casing w/ 60,177#'s of 20/40 sand in 941 bbls of Lightning 30 frac fluid. Open well w/ 0 psi on casing. Perfs broke down @ 2700 psi. Pump 30 gals of Techna Hib chemical @ 4% by volume. Treated @ ave pressure of 2870 @ ave rate of 25 bpm w/ 5 ppg of sand. Spot 12 bbls of 15% HCL acid in flush for next stage. ISIP was 3046. 1094 bbls EWTR. Leave pressure on well. RU PSI WLT, crane & lubricator. RIH w/ Weatherford 5-1/2" (6K) composite flow through frac plug & 6', 10' perf guns. Set plug @ 5150'. Perforate D1 sds @ 5020-26' & DS3 sds @ 4980-90' w/ 3-1/8" Slick Guns (23 gram, .37" HE, 120°) w/ 4 spf for total of 64 shots. RU BJ & frac stage #2 w/ 40,722#'s of 20/40 sand in 402 bbls of Lightning 15 frac fluid. Open well w/ 1305 psi on casing. Perfs broke down @ 1965 psi. Pump 30 gals of Techna Hib chemical @ 4% by volume. Treated @ ave pressure of 2709 @ ave rate of 23.1 bpm w/ 8 ppg of sand. Spot 12 bbls of 15% HCL acid in flush for next stage. ISIP was 4200. Screened out frac when 8# on perfs, 2788#'s in casing, 39,934#'s in perfs. Flow well back. Well flowed for hours & died w/ bbls rec'd. 1496 bbls EWTR. RU WLT. RIH w/ frac plug & 14' perf gun. Set plug @ 4950'. Perforate DS2 sds @ 4906-20' w/ 4 spf for total of 56 shots. Stuck guns @ 4858'. Pull of wireline & leave collar locator, gun, & setting tool in hole. RD BJ & WLT. SIFN.

9/20/2008 Day: 3**Completion**

Nabors #823 on 9/19/2008 - MIRUSU. Open well w/ 25 psi on casing. RD Cameron BOP's. Instal Schaffer BOP's w/ pipe rams. PU 3-1/8" graphel, jars, bumper sub. Tally & pickup TIH w/ new J-55, 2-7/8", 6.5# tbg to tag sand @ 4690'. RU pump & tanks. Circulate well clean. SIFN.

9/21/2008 Day: 4**Completion**

Nabors #823 on 9/20/2008 - Open well w/ 0 psi on casing. RU pump & tanks. Circulate well clean to fish to 4890'. Circulate well clean. Latch onto fish. TOOH w/ tbg. LD tools & fish. TIH w/ NC & tbg to tag fill @ 4883'. C/O to plug @ 4950'. LD 2 jts tbg. SIFN.

9/23/2008 Day: 5**Completion**

Nabors #823 on 9/22/2008 - Open well w/ 0 psi on casing. RU pump & tanks. Circulate well clean to plug @ 4950'. TOOH w/ tbg. RD Schaffer BOP's. Instal Cameron BOP's. RU BJ Services "Ram Head" frac flange. RU BJ & frac DS2 sds, stage #3 down casing w/ 35,888#'s of 20/40 sand in 359 bbls of Lightning 17 frac fluid.

Open well w/ 0 psi on casing. Perfs broke down @ 2085 psi. Pump 30 gals of Techna Hib chemical @ 4% by volume. Treated @ ave pressure of 2997 w/ ave rate of 28.3 bpm w/ 6 ppg of sand. Spot 12 bbls of 15% HCL acid in flush for next stage. ISIP was NA. 1675 bbls EWTR. Screened out frac w/ 13,536#'s in perfs w/ 22,352#'s in casing when went to flush w/ 5# on perfs. No flow back. RD WLT & BJ. RD Cameron BOP's. Instal Schaffer BOP's. TIH w/ NC, 110 jts tbg to tag sand. C/O to 4800'. TOOH w/ tbg. SIFN.

9/24/2008 Day: 6

Completion

Nabors #823 on 9/23/2008 - Open well w/ 0 psi on casing. RD Schaffer BOP's. Instal Cameron BOP's. RU PSI WLT & lubricator. RIH w/ frac plug & 20' perf gun. Set plug @ 4650'. Perforate GB6 sds @ 4576-96' w/ 4 spf for total of 80 shots. RU BJ Services "Ram Head" frac flange. RU BJ & frac GB6 sds, stage #4 down casing w/ 41,794#'s of 20/40 sand in 514 bbls of Lightning 17 frac fluid. Perfs broke down @ 3063 psi. Pump 30 gals of Techna Hib chemical @ 4% by volume. Treated @ ave pressure of 2177 w/ ave rate of 23.3 bpm w/ 6 ppg of sand. ISIP was 1765. 2186 bbls EWTR. RD WLT & BJ. Flow well back. Well flowed for 1.5 hours & died w/ 250 bbls rec'd. RD Cameron BOP's. Instal Schaffer BOP's. RU 4-3/4" Chomp mill & x-over sub. TIH w/ tbg to tag sand (30'). C/O to plug @ 4650'. RU swivel, pump & tanks. Drlg out plug #1. SIFN.

9/25/2008 Day: 7

Completion

Nabors #823 on 9/24/2008 - Open well w/ 0 psi on casing. RU swivel, pump & tanks. Continue drlg out plug #1. Call for different swivel. TIH w/ tbg to tag sand @ 130'. C/O to plug @ 4950'. Drlg out plug #2. TIH w/ tbg to tag plug @ 5150'. Drlg out plug #3. TIH w/ tbg to tag sand @ 151'. C/O to PBD @ 6411'. LD 4 jts tbg. EOT @ 6261'. SIFN.

9/26/2008 Day: 8

Completion

Nabors #823 on 9/25/2008 - Open well w/ 0 psi on casing. RU swab equipment. Made 20 runs to rec'd 144 bbls fluid. IFL was surface. FFL was 800'. Last run showed trace of oil w/ no sand. RD swab. TIH w/ tbg. Circulate well clean to PBD @ 6411'. TOOH w/ tbg. LD mill & x-over sub. TIH w/ NC, 1 jts tbg, SN, 3 jt, TA CDI new w/ 45,000# shear, 30 jts tbg. Well started to flow. Pump 30 bbls down tbg. TIH w/ 60 jts. Pump 50 bbls water down tbg. TIH w/ 40 jts. SIFN.

9/27/2008 Day: 9

Completion

Nabors #823 on 9/26/2008 - Open well w/ 0 psi on casing. Circulate 50 bbls down tbg. Continue TIH w/ tbg. RD BOP's. Set TA @ 6134' w/ 16,000#'s tension w/ SN @ 6226' & EOT @ 6269'. Flush tbg w/ 50 bbls of water. Pickup & prime pump. TIH w/ 2-1/2" x 1-1/2" x 16' x 20' RHAC new CDI pump w/ 175"SL, 4- 1-1/2" weight rods, 245- 7/8" guided rods, 2', 6', 8' x 7/8" pony rod, 1-1/2" x 26' polish rod. Space pump. Test tbg & pump to 800 psi. RDMOSU. POP @ 6PM @ 4 spm w/ 145" SL. Final Report.

Pertinent Files: Go to File List